

149 HANSWORTH STREET M UNDER GROUPA V E 3 1 7 0



Series TA Main drawings

TA01 Cover Sheet

TA02 Site Context

TA03 Site Response

TA04 Tower Grnd Lwr / Units part Grnd Floor

TA05 Tower Ground Flr / Units Ground Flr

TA06 Tower 1st Floor / Units 1st Floor

TA07 Tower 2nd Floor / Units 2nd Floor

TA08 Tower 3rd, 4th, 5th, & 6th Floors

TA09 Tower 7th Floor

TA10 Tower 8th Floor

TA11 Tower Roof Plan

TA12 Units detail plans - Ground Floor

TA13 Units detail plans - First Floor

TA14 Units detail plans - Second Floor

TA15 Tower Ground Lower

TA16 Tower Ground Floor

TA17 Tower 1st Floor

TA18 Tower 2nd Floor

TA19 Tower 3rd, 4th, 5th, & 6th Floors

TA20 Tower 7th Floor

TA21 Tower 8th Floor

TA22 Tower Roof Plans

Series TB Elevations & sections

TB01 Terrace / Units Elevations

TB02 Terrace / Units Elevations

TB03 Terrace / Units Elevations

TB04 Tower - North & East Elevations

TB05 Tower - South & West Elevations

TB06 Sectional Views

TB07 Sectional Views

TB08 Sectional Views

TB09 Sectional Views

Series TC Detailed drawings

TC01 Easement relocation

TC02 Indicative Landscape plan

TC03 Shadow diagrams

TC04 Shadow diagrams

TC05 Materials & Finishes Schedule

TC06 Perspective Views - Units

TC07 Perspective Views - Tower

TC08 Fence types & mailboxes

Series TD Details

TD01 Proposed Path treatment


TD02 Path Sectional views

TD03 Path Sectional views

TD04 Path Sectional views

TD05 Path Graphical image



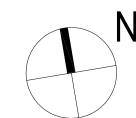

PROJECT:
149 HANSWORTH STREET
MULGRAVE VIC 3170
CLIENT: PONG PROPERTY DEVELOPMENT P/L
DRAWING TITLE:
COVER SHEET

- INFORMATION
DATE: SCALE: N.T.S. @ A1

N.T.S. @ A3

TA01

PLANNING & ENVIRONMENT ACT 1987

MONASH PLANNING SCHEME
Plan referred to in Permit No. TPA 45451

For and on behalf of the City of Monash: James Heitmann Sheet 1 of 40

Date: 23/04/19

N. T. S. @ A1

N. T. S. @ A3

REV:

P5 MAR 18 2019


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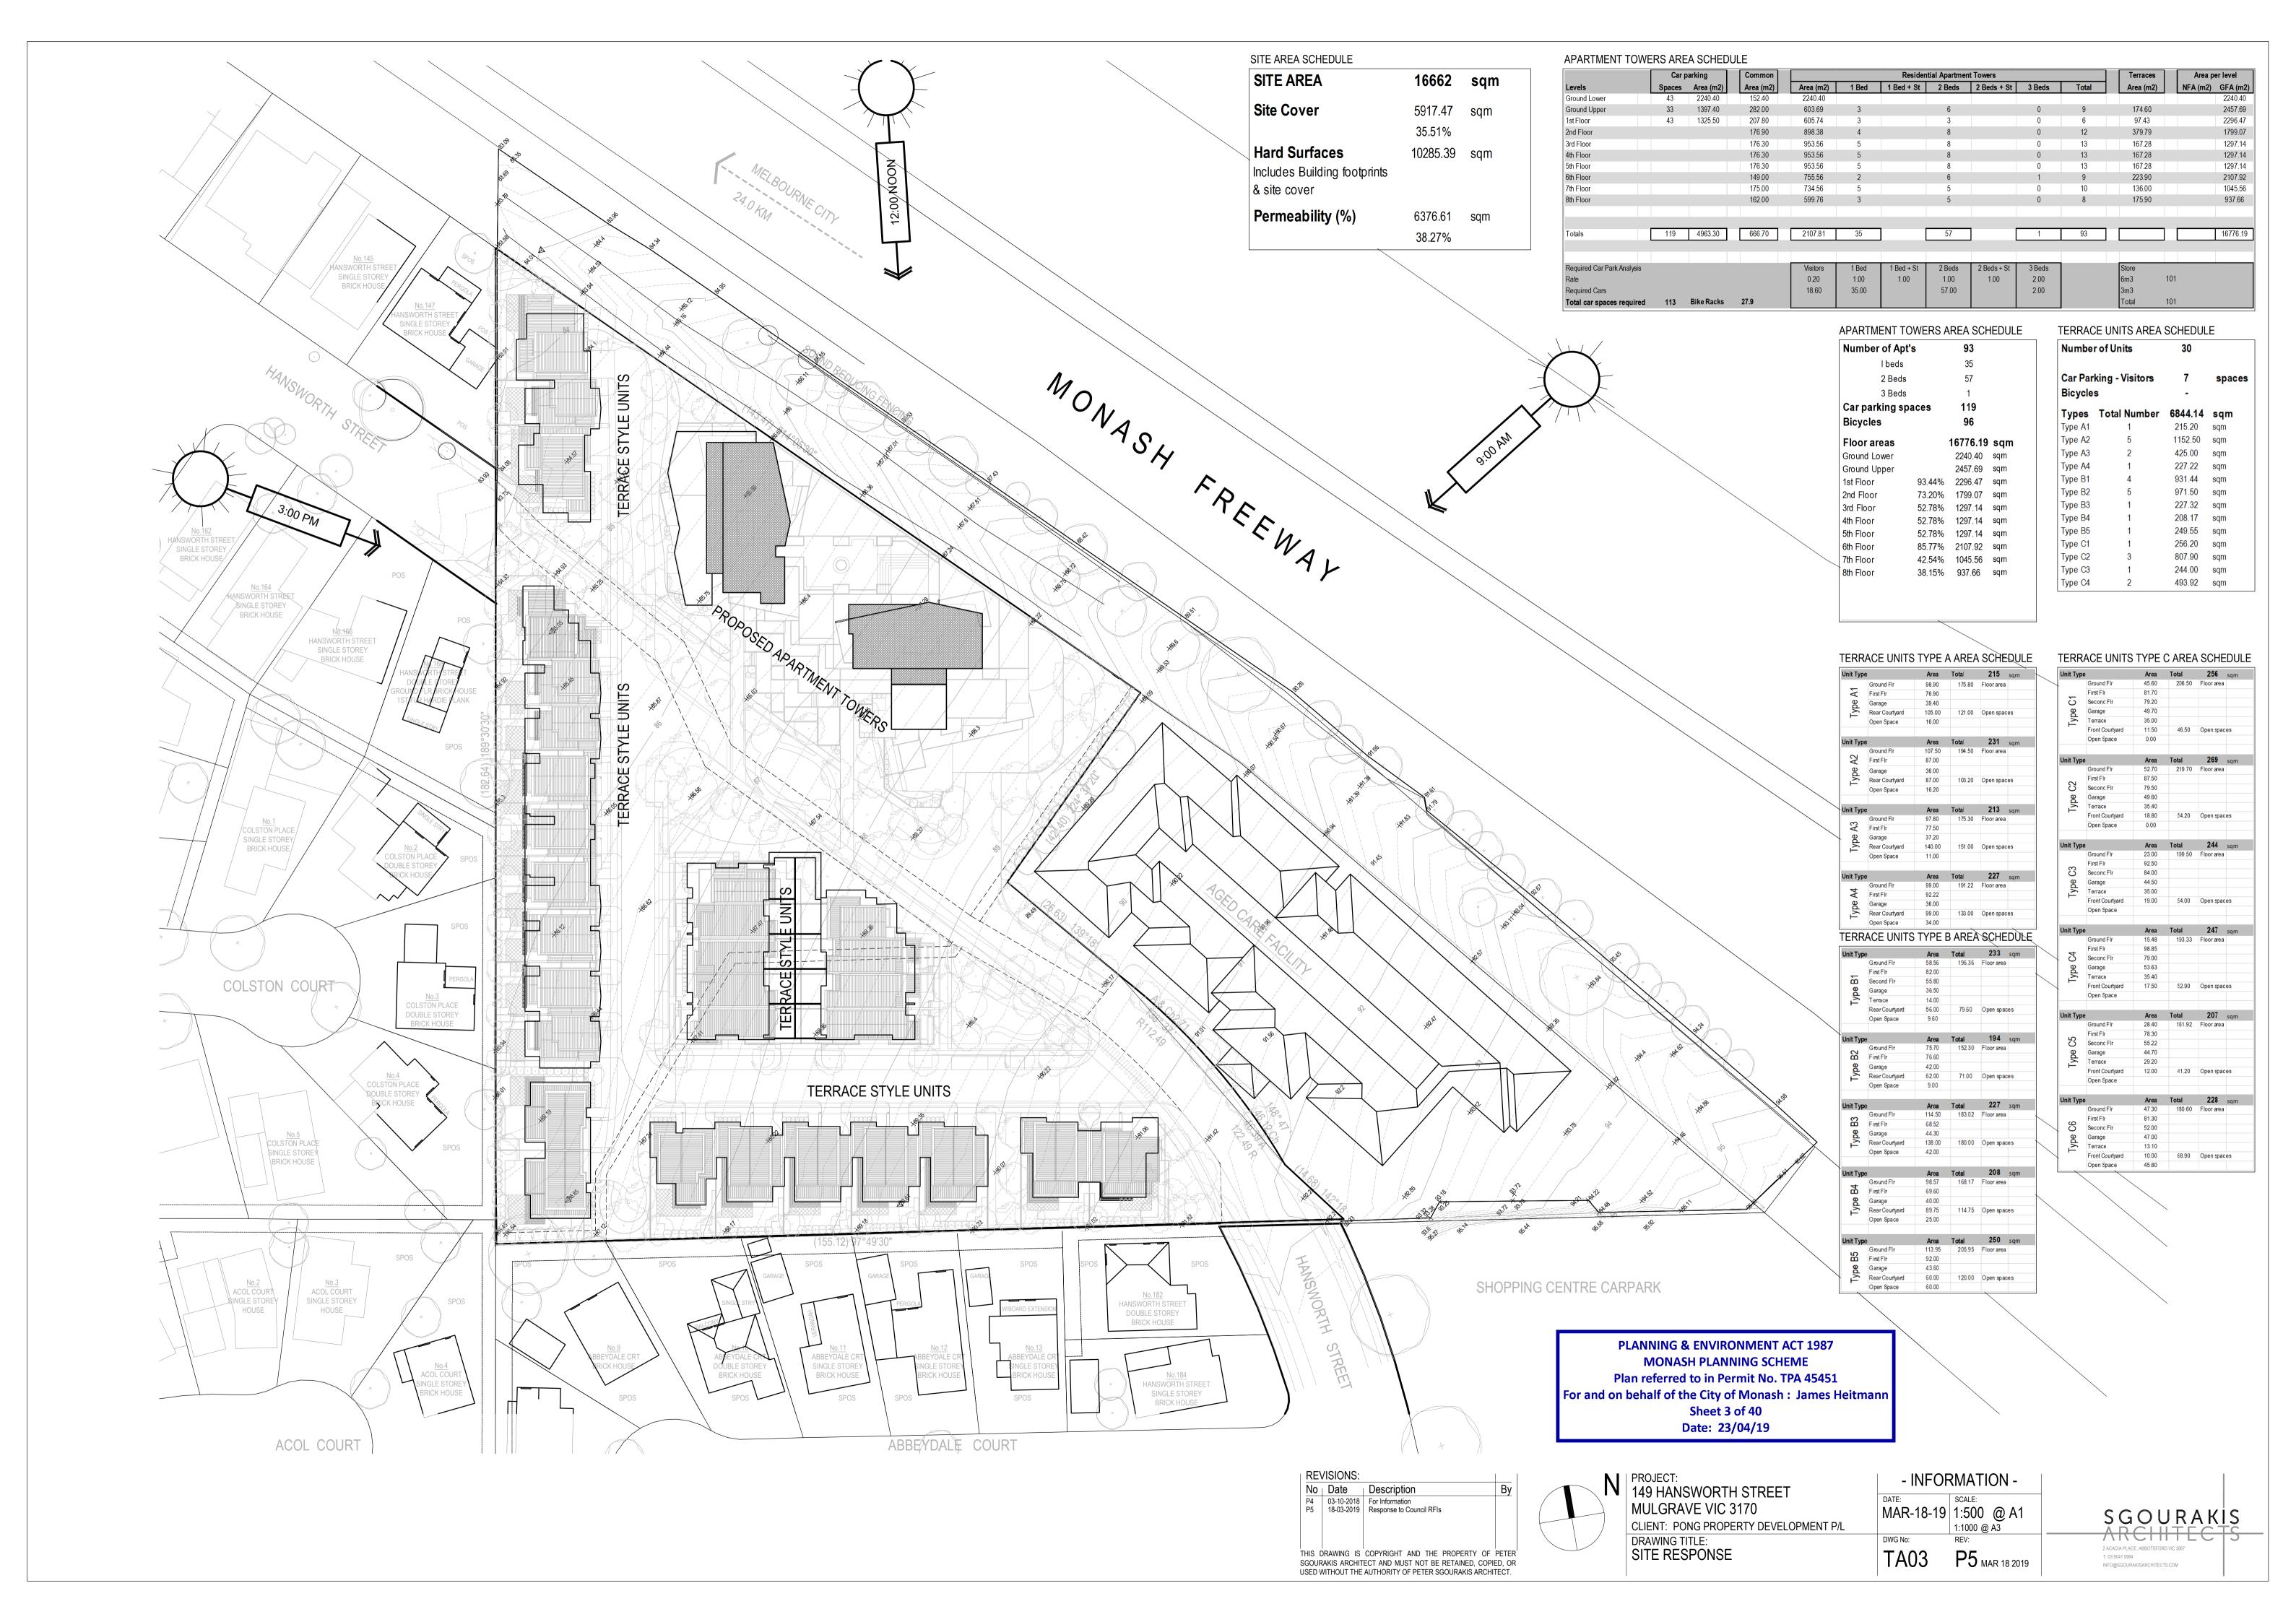
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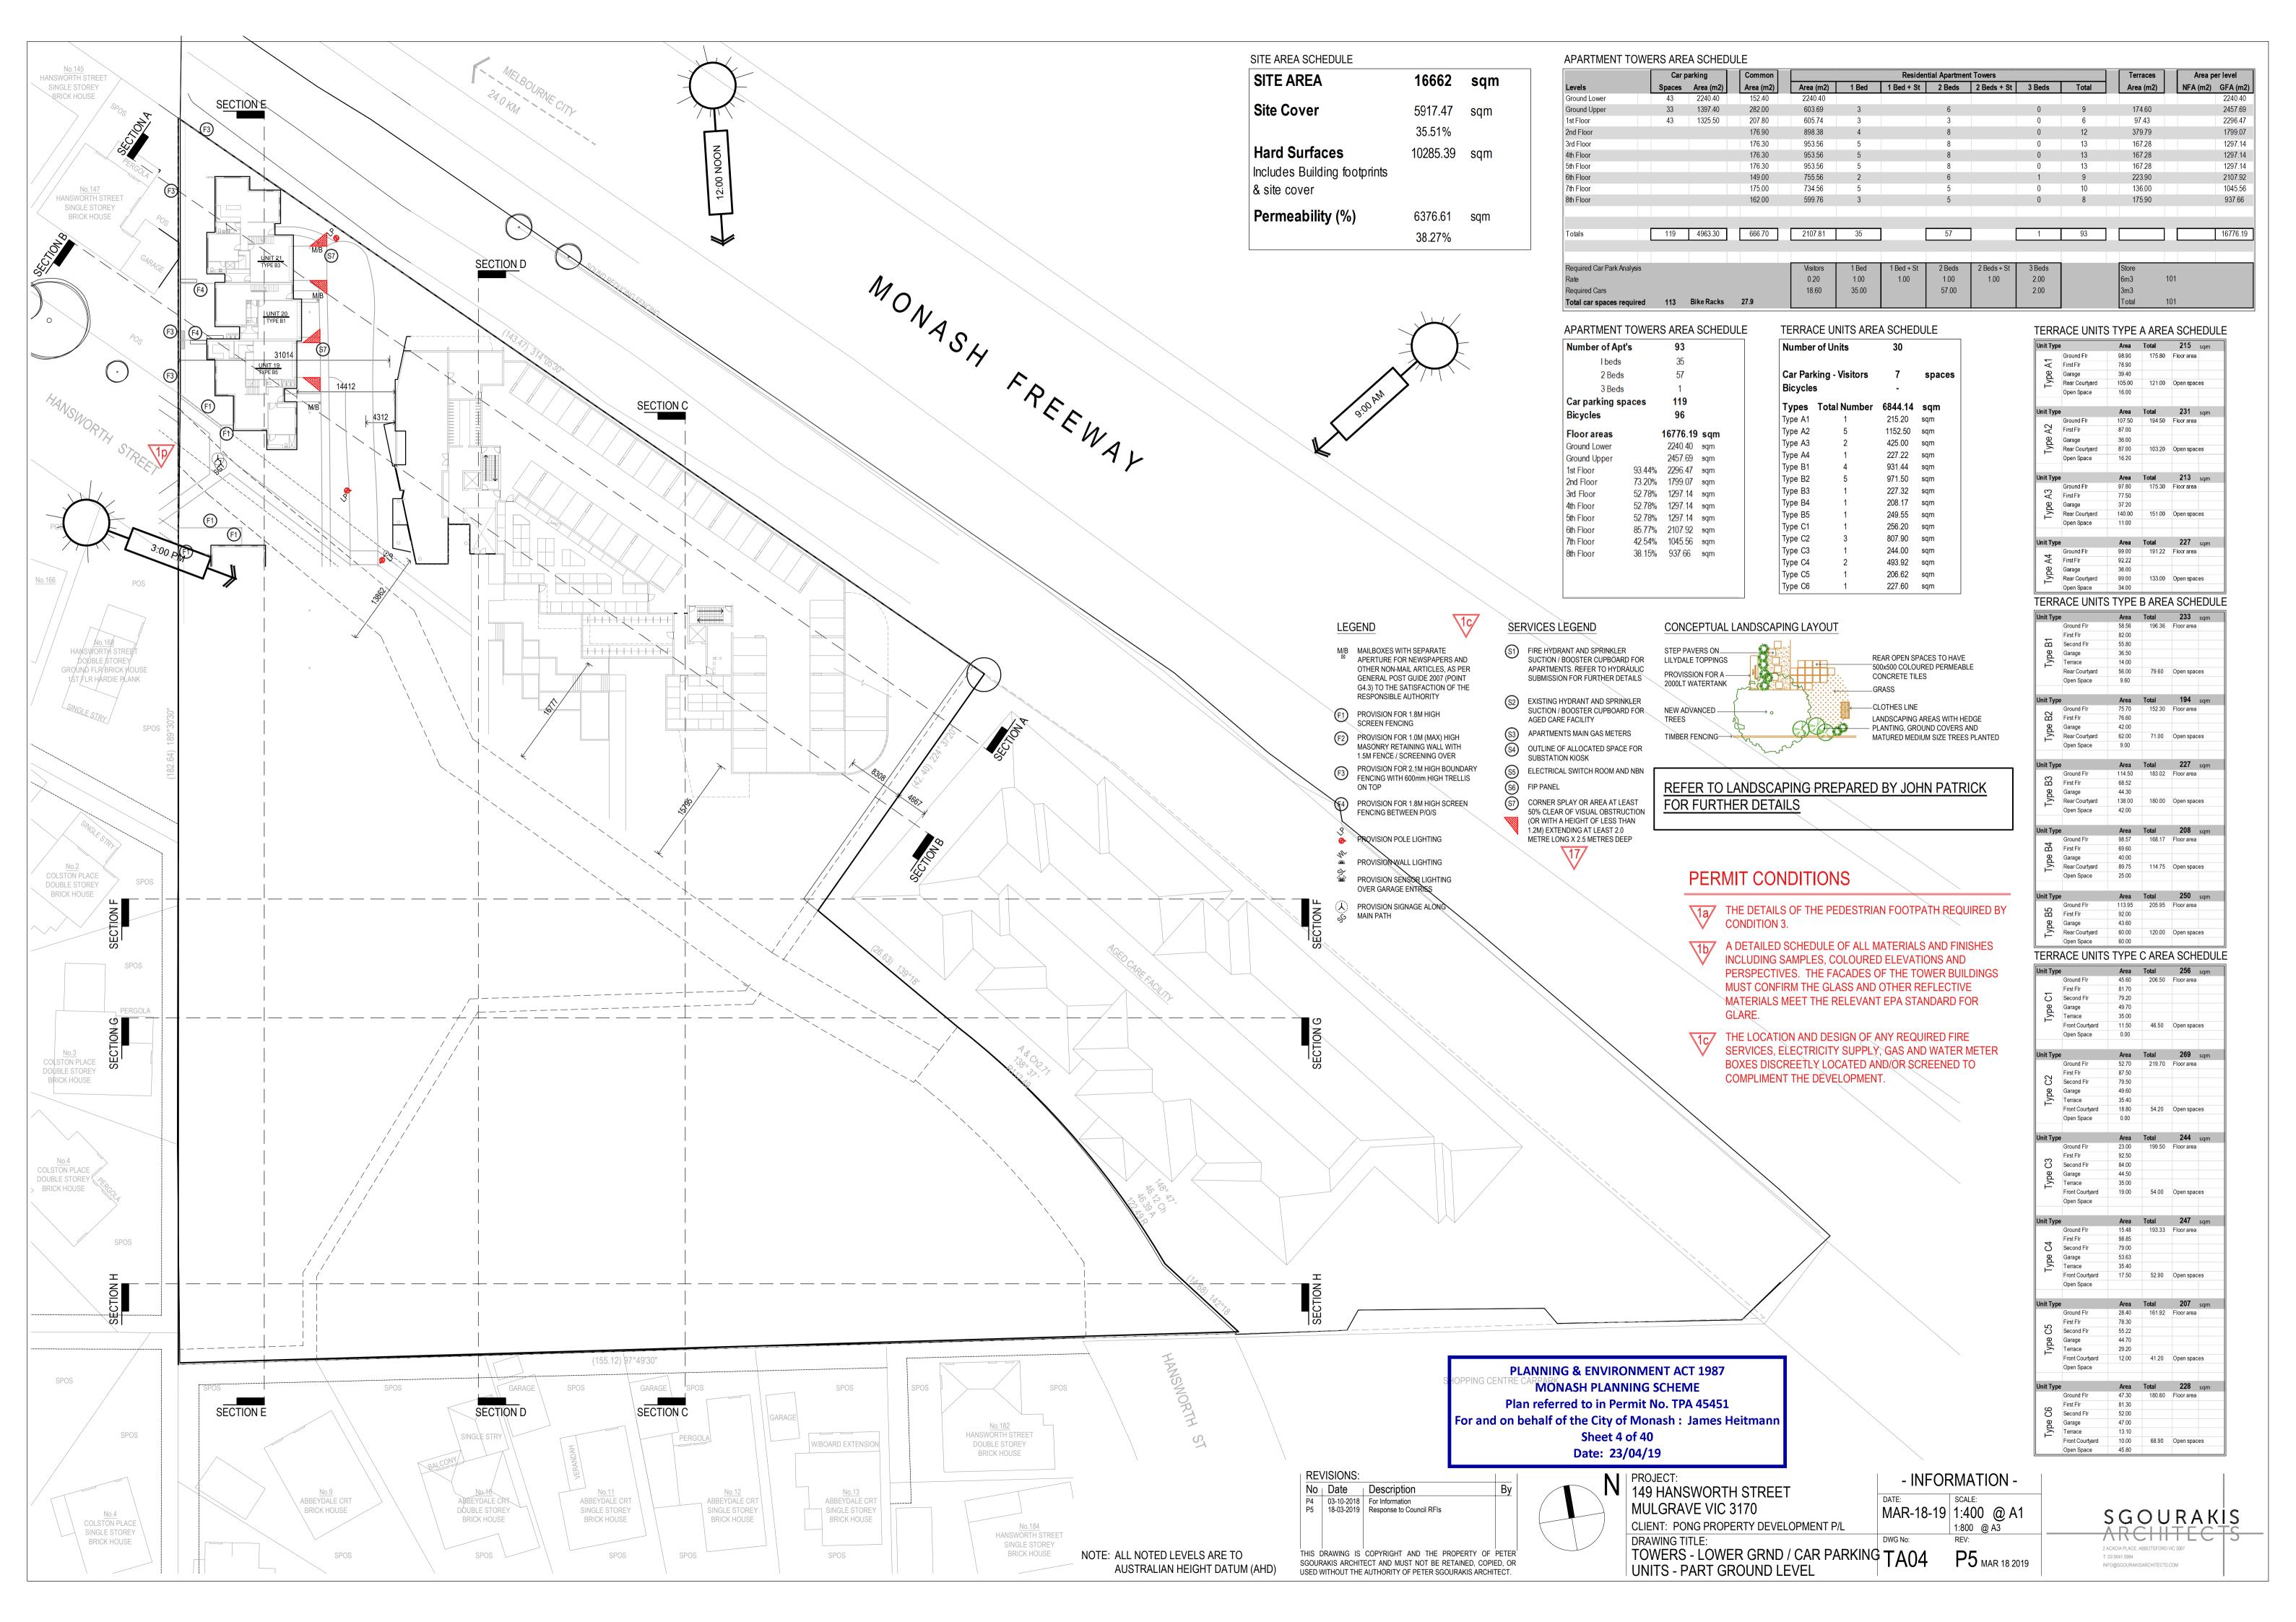
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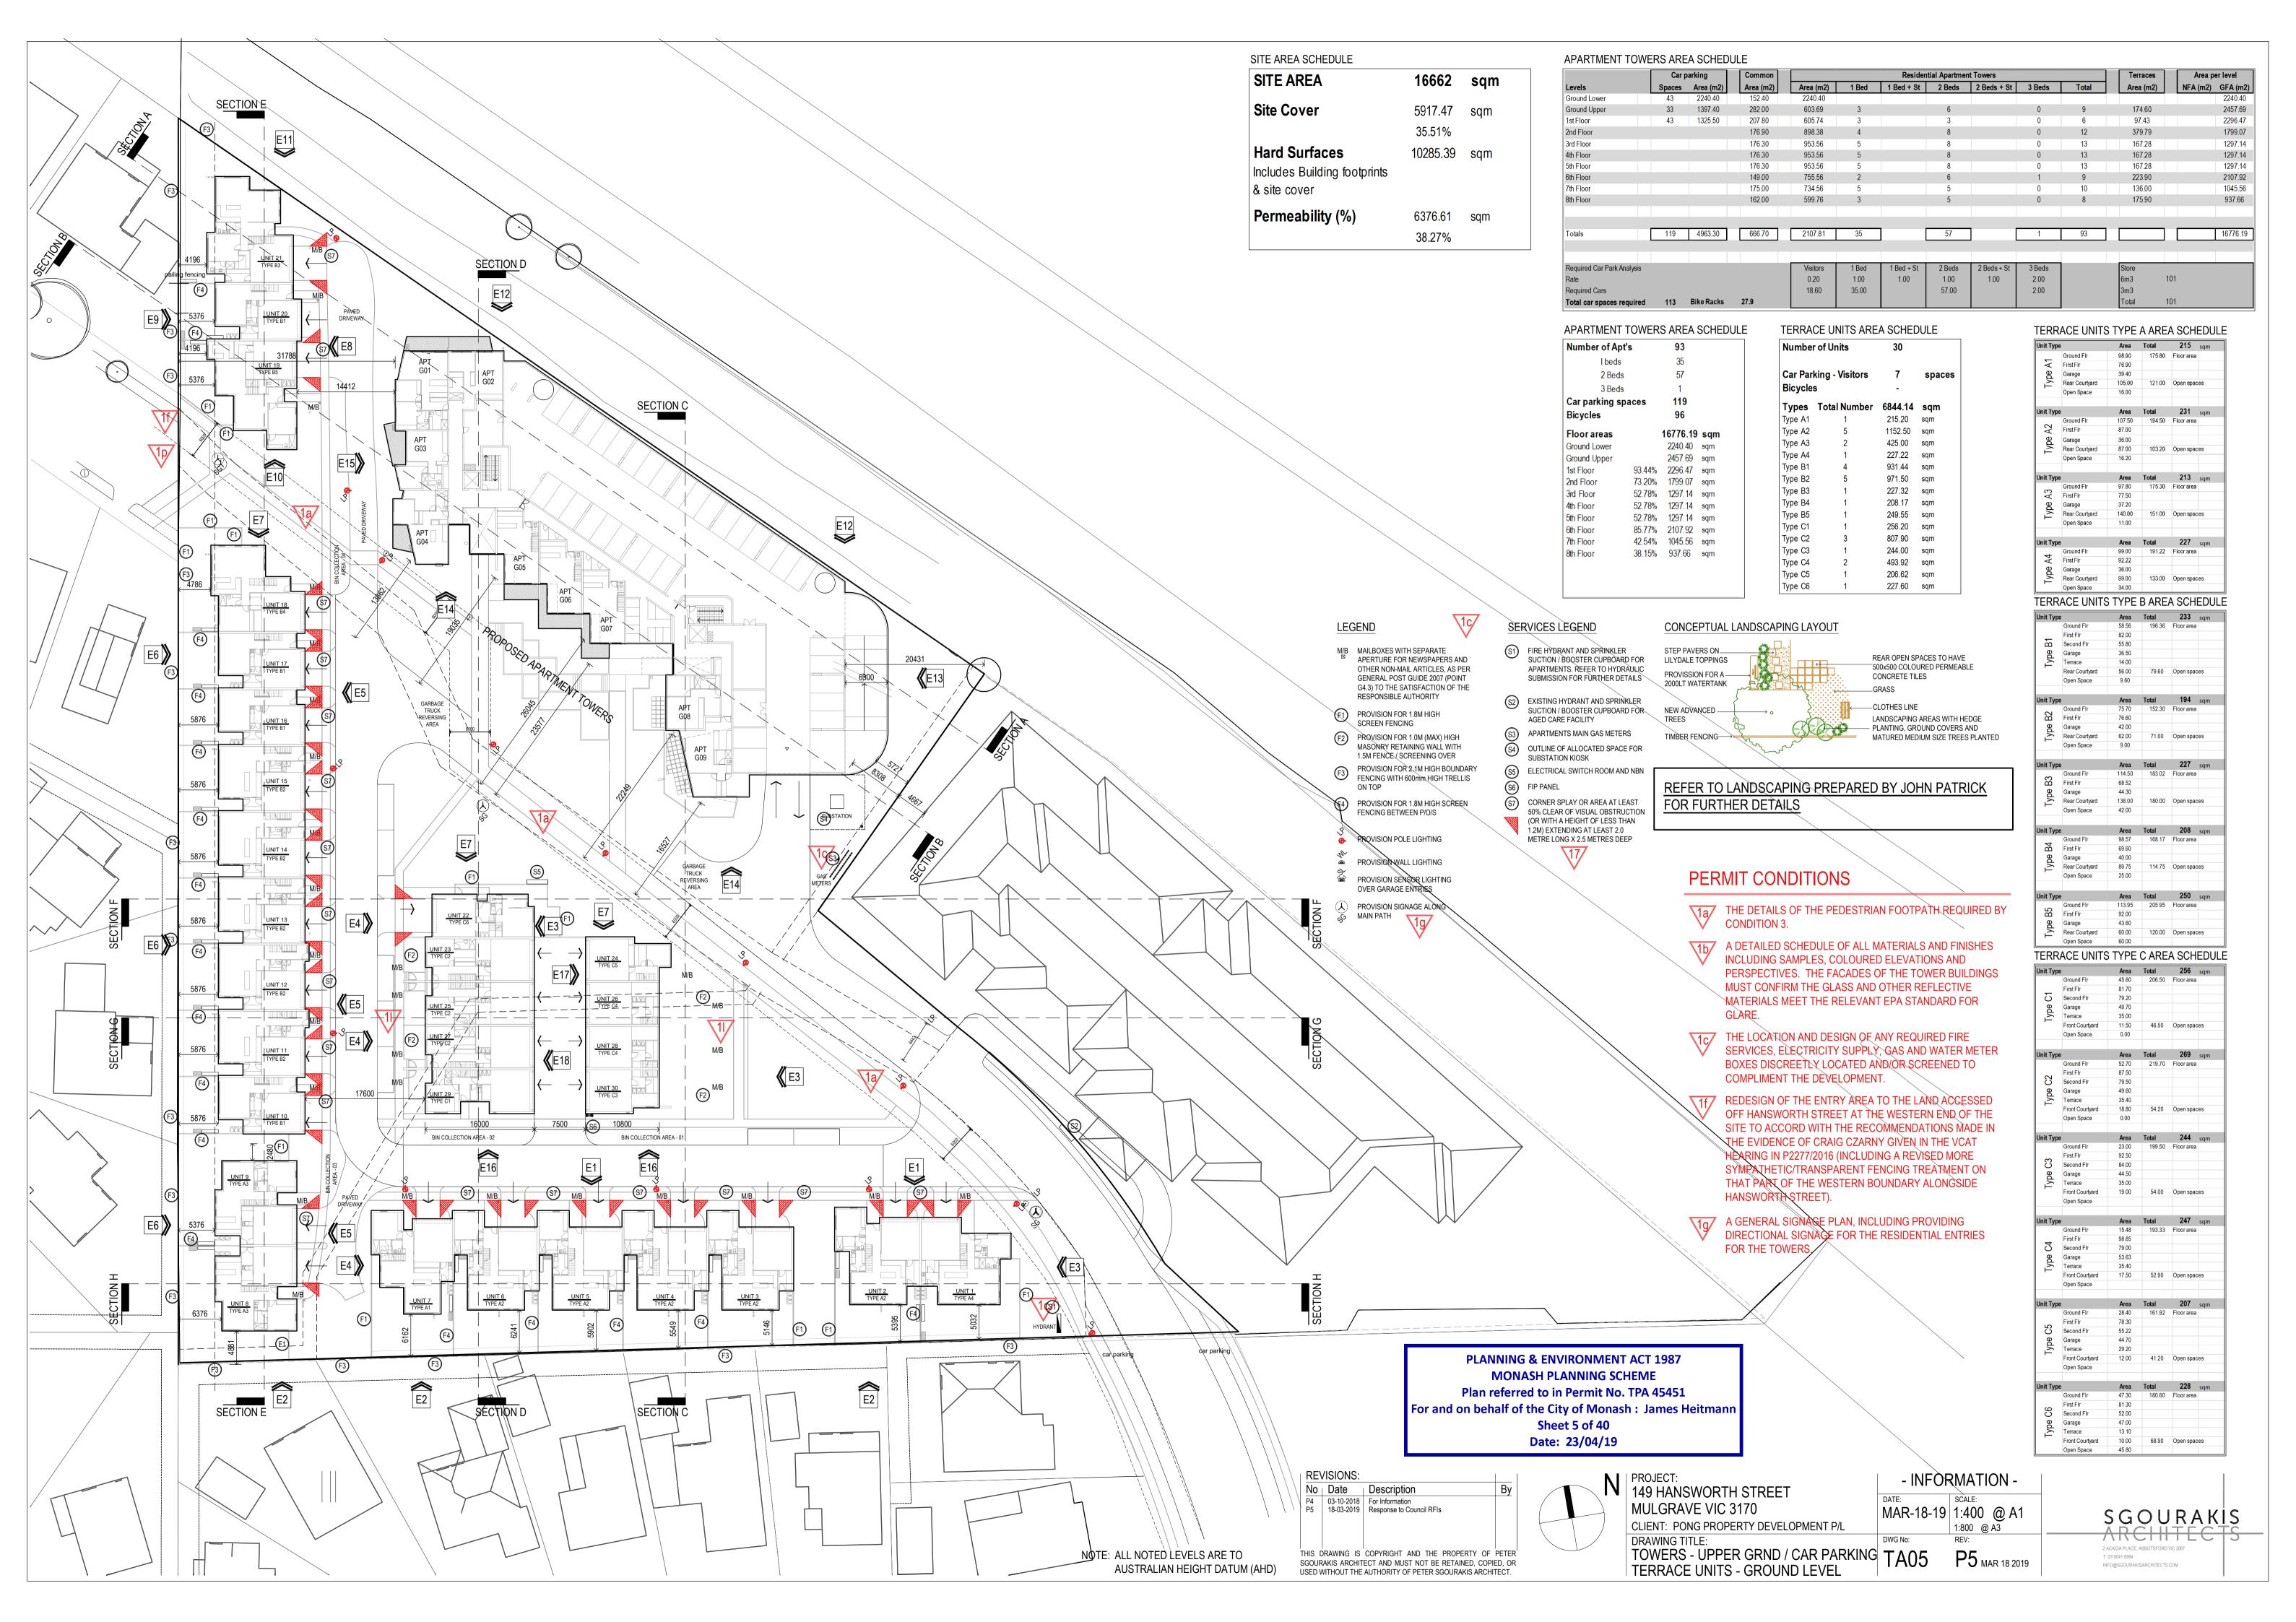
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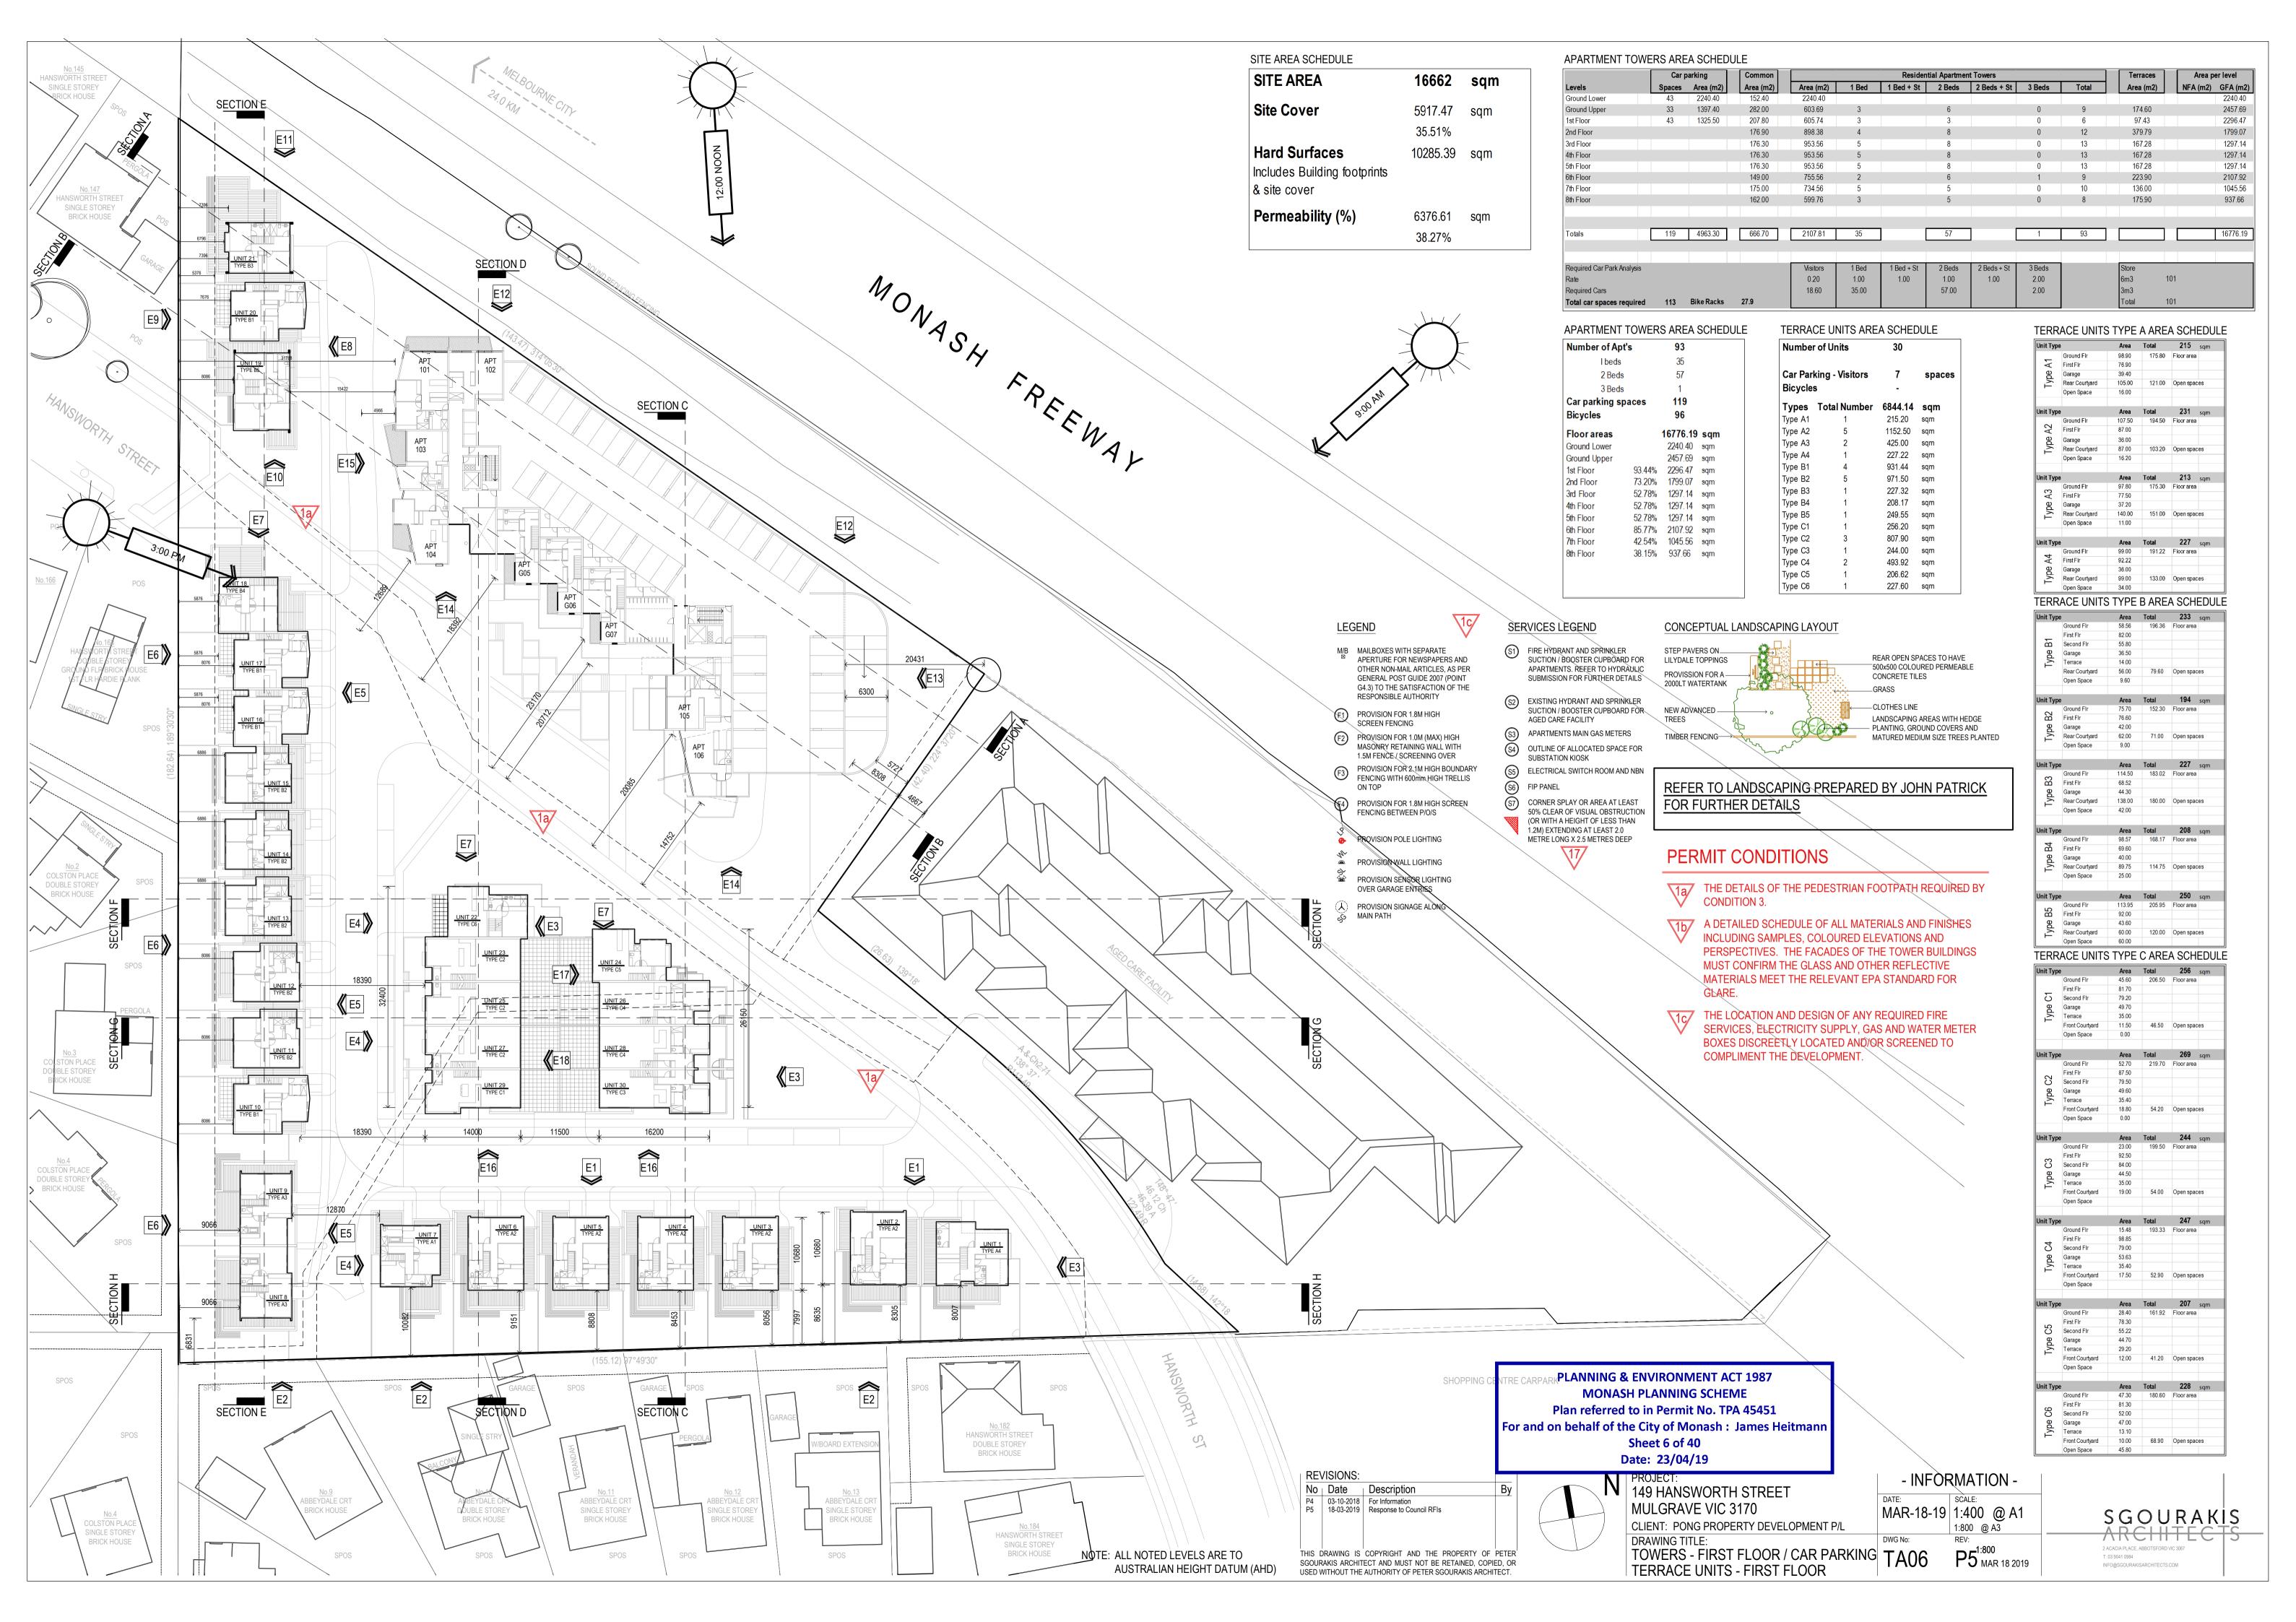
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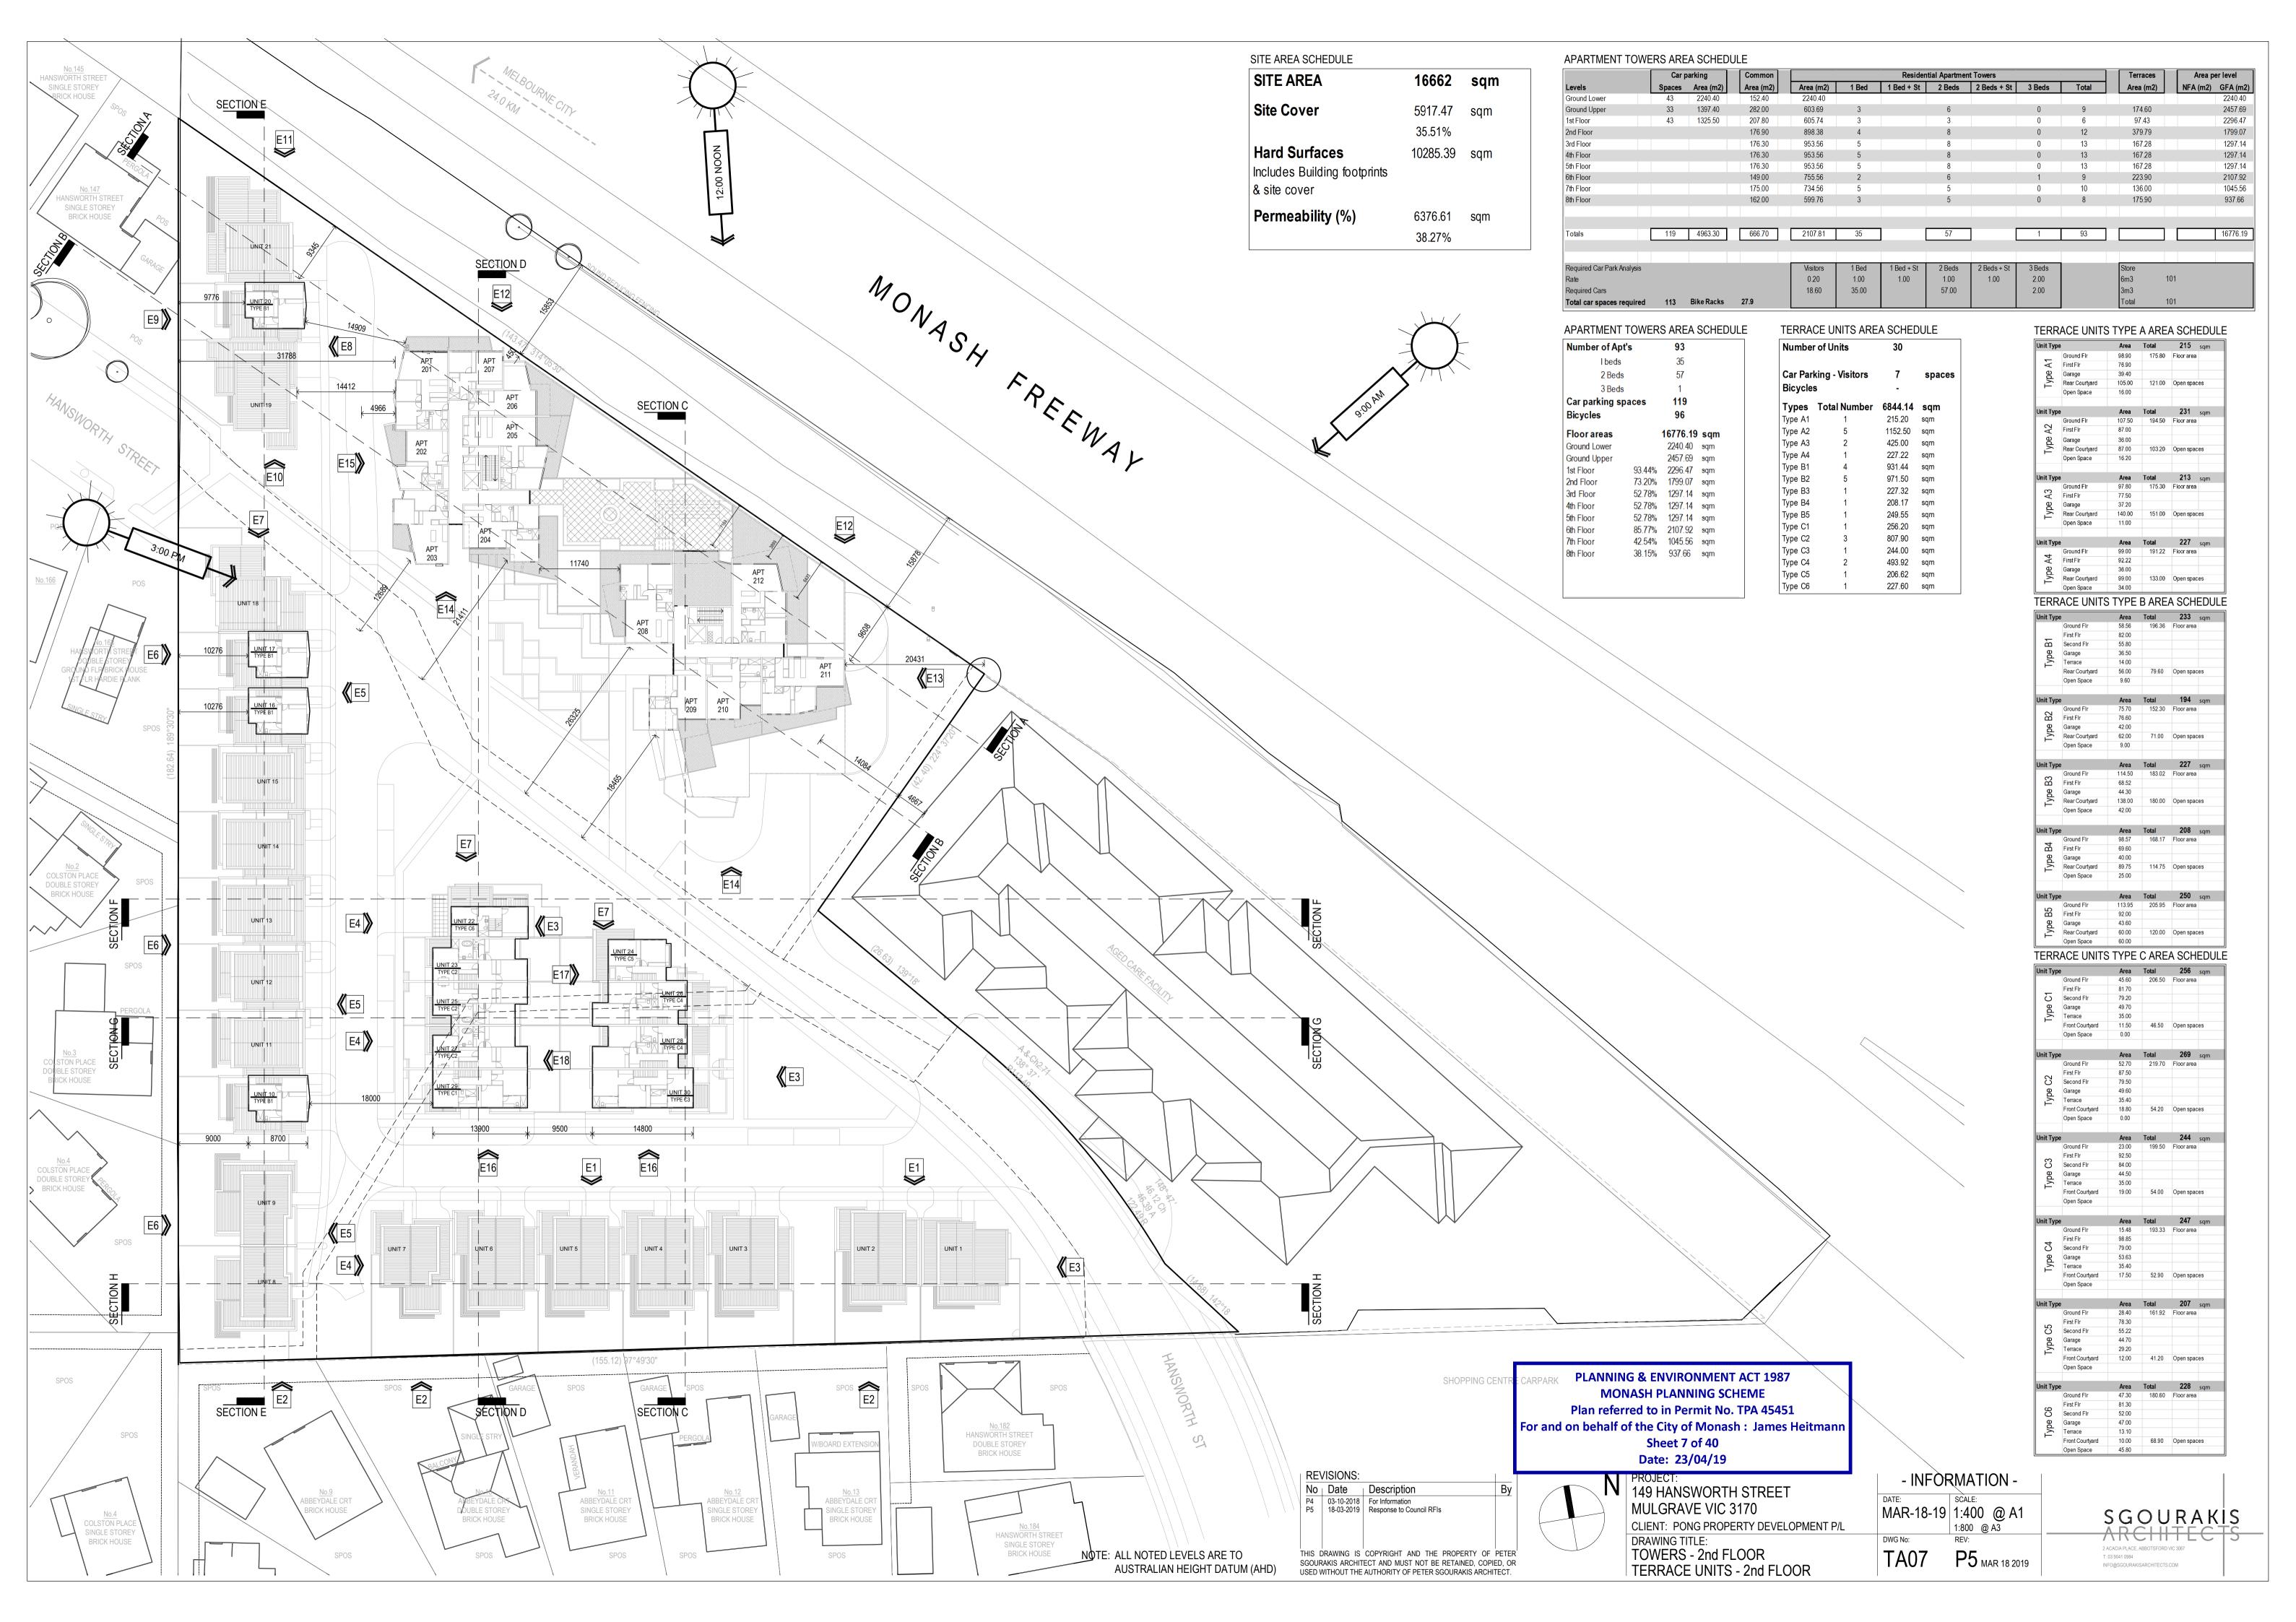














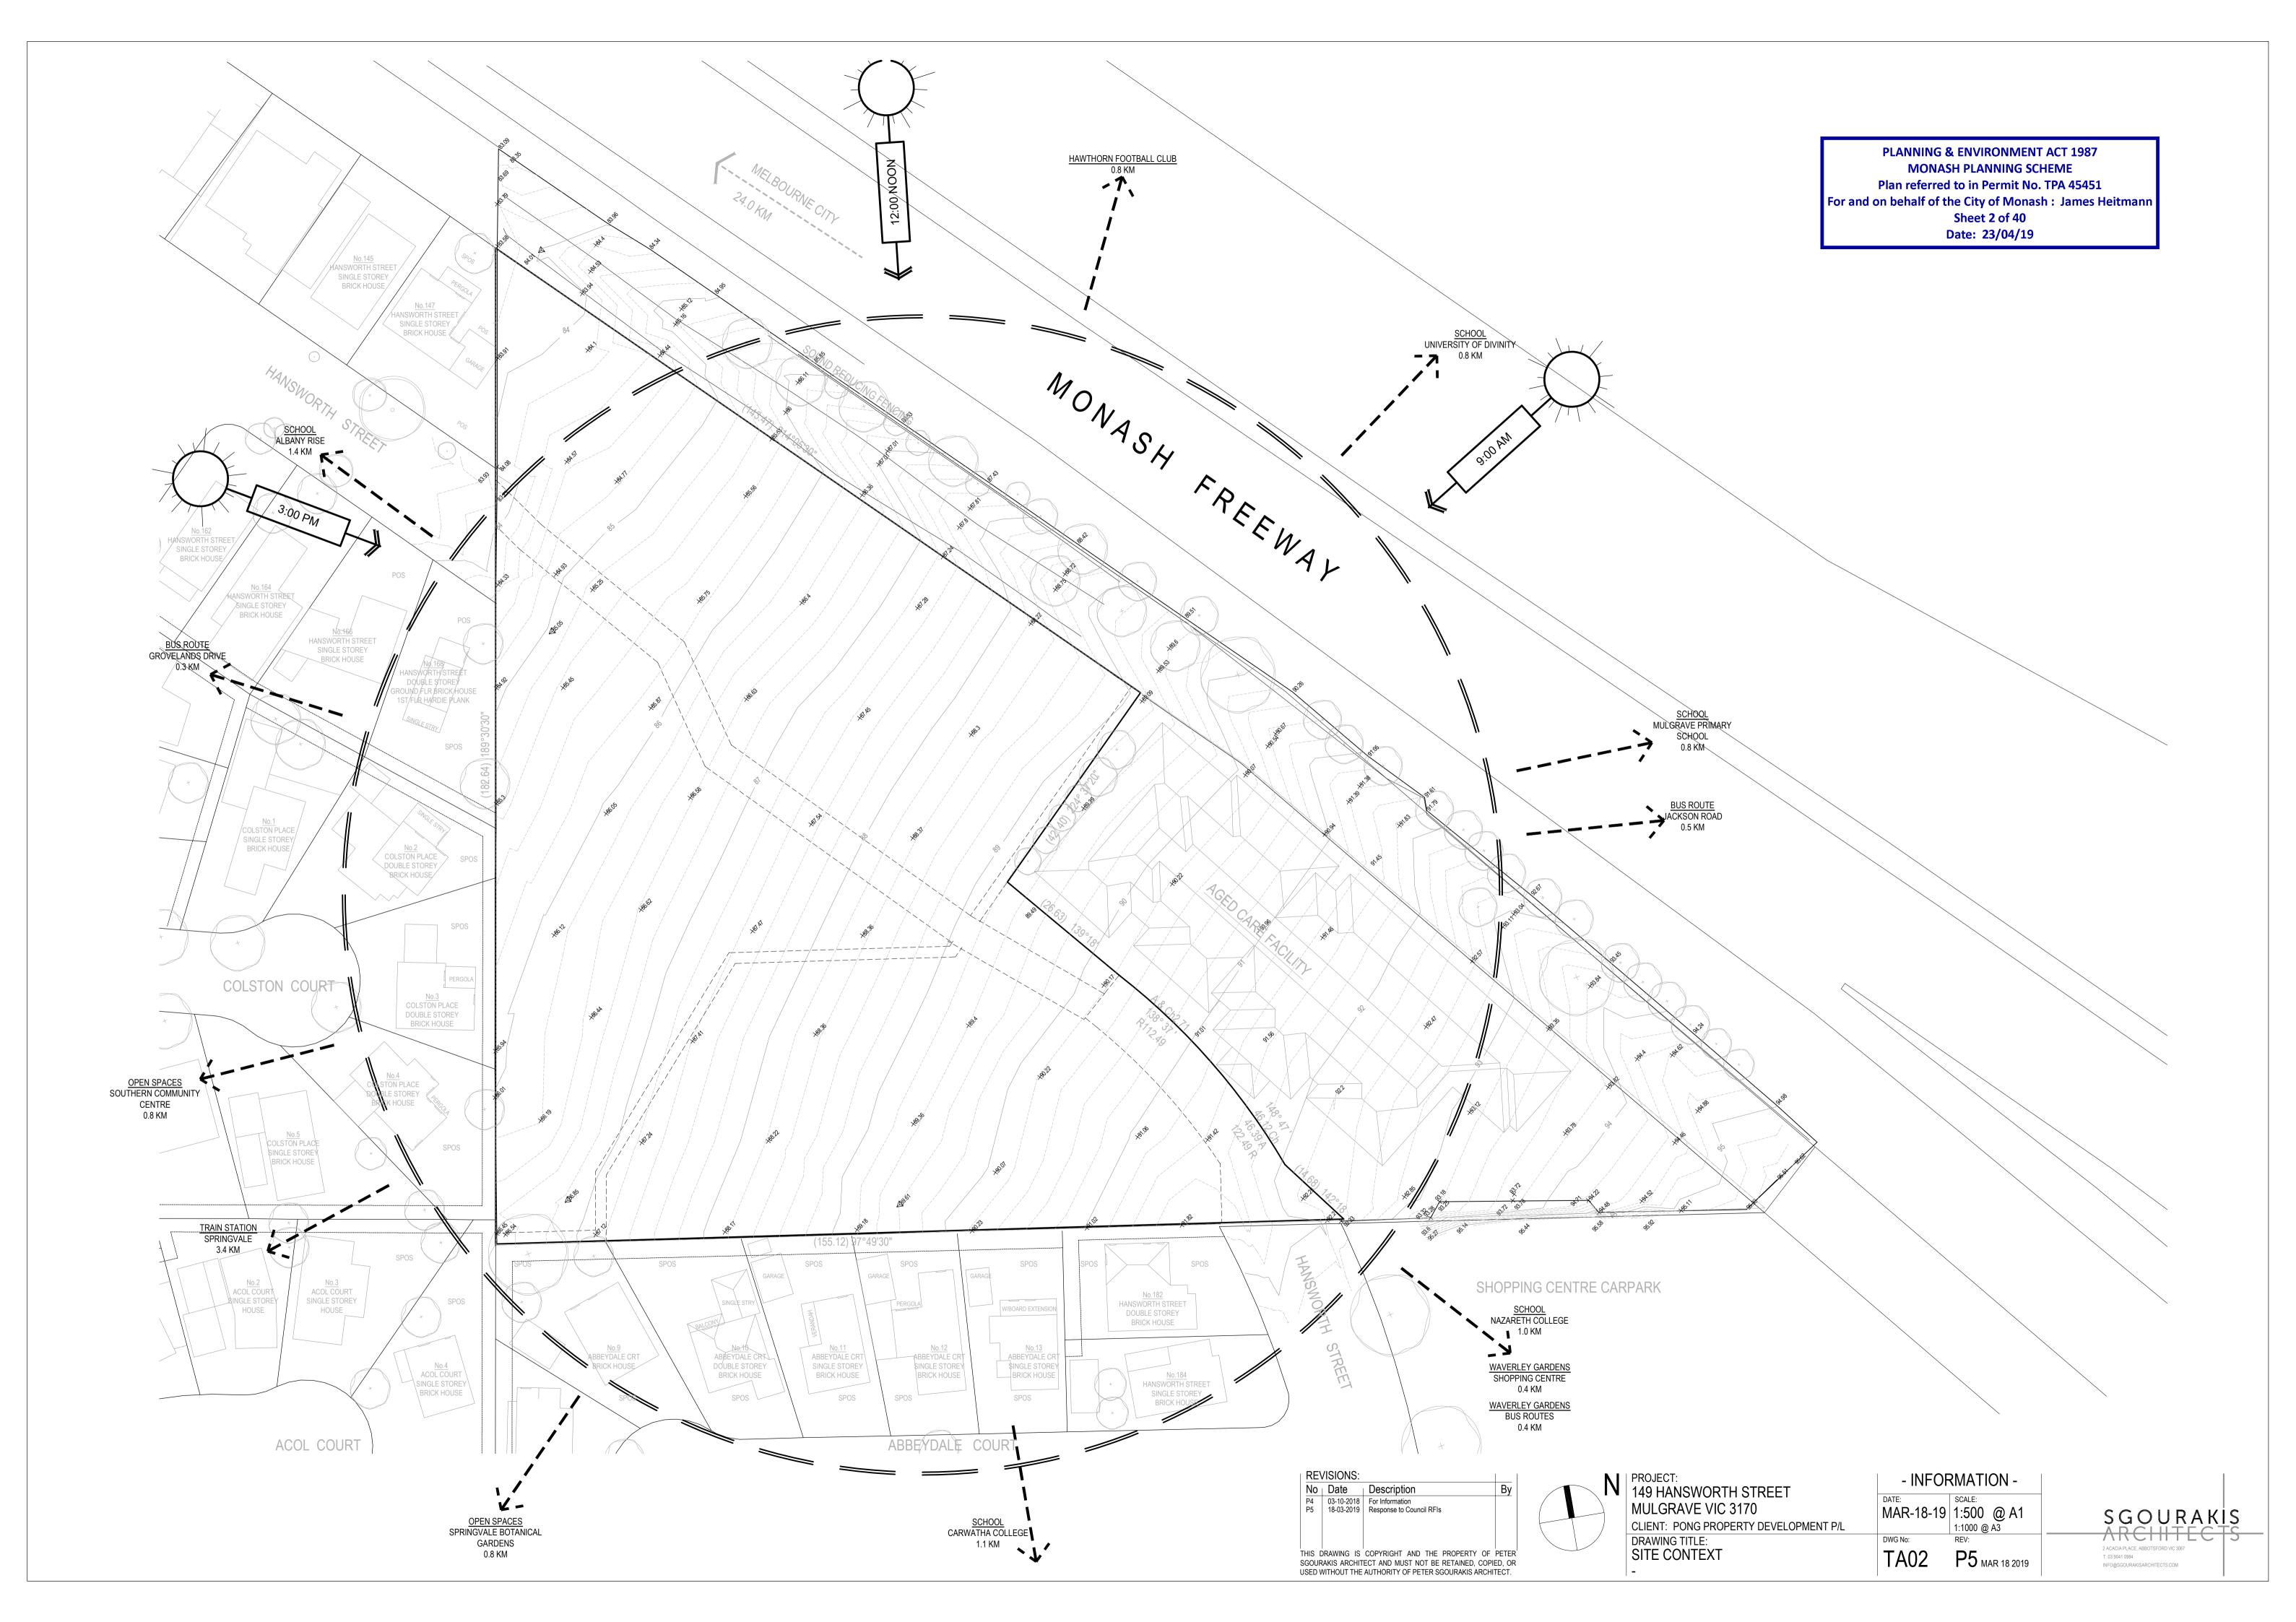


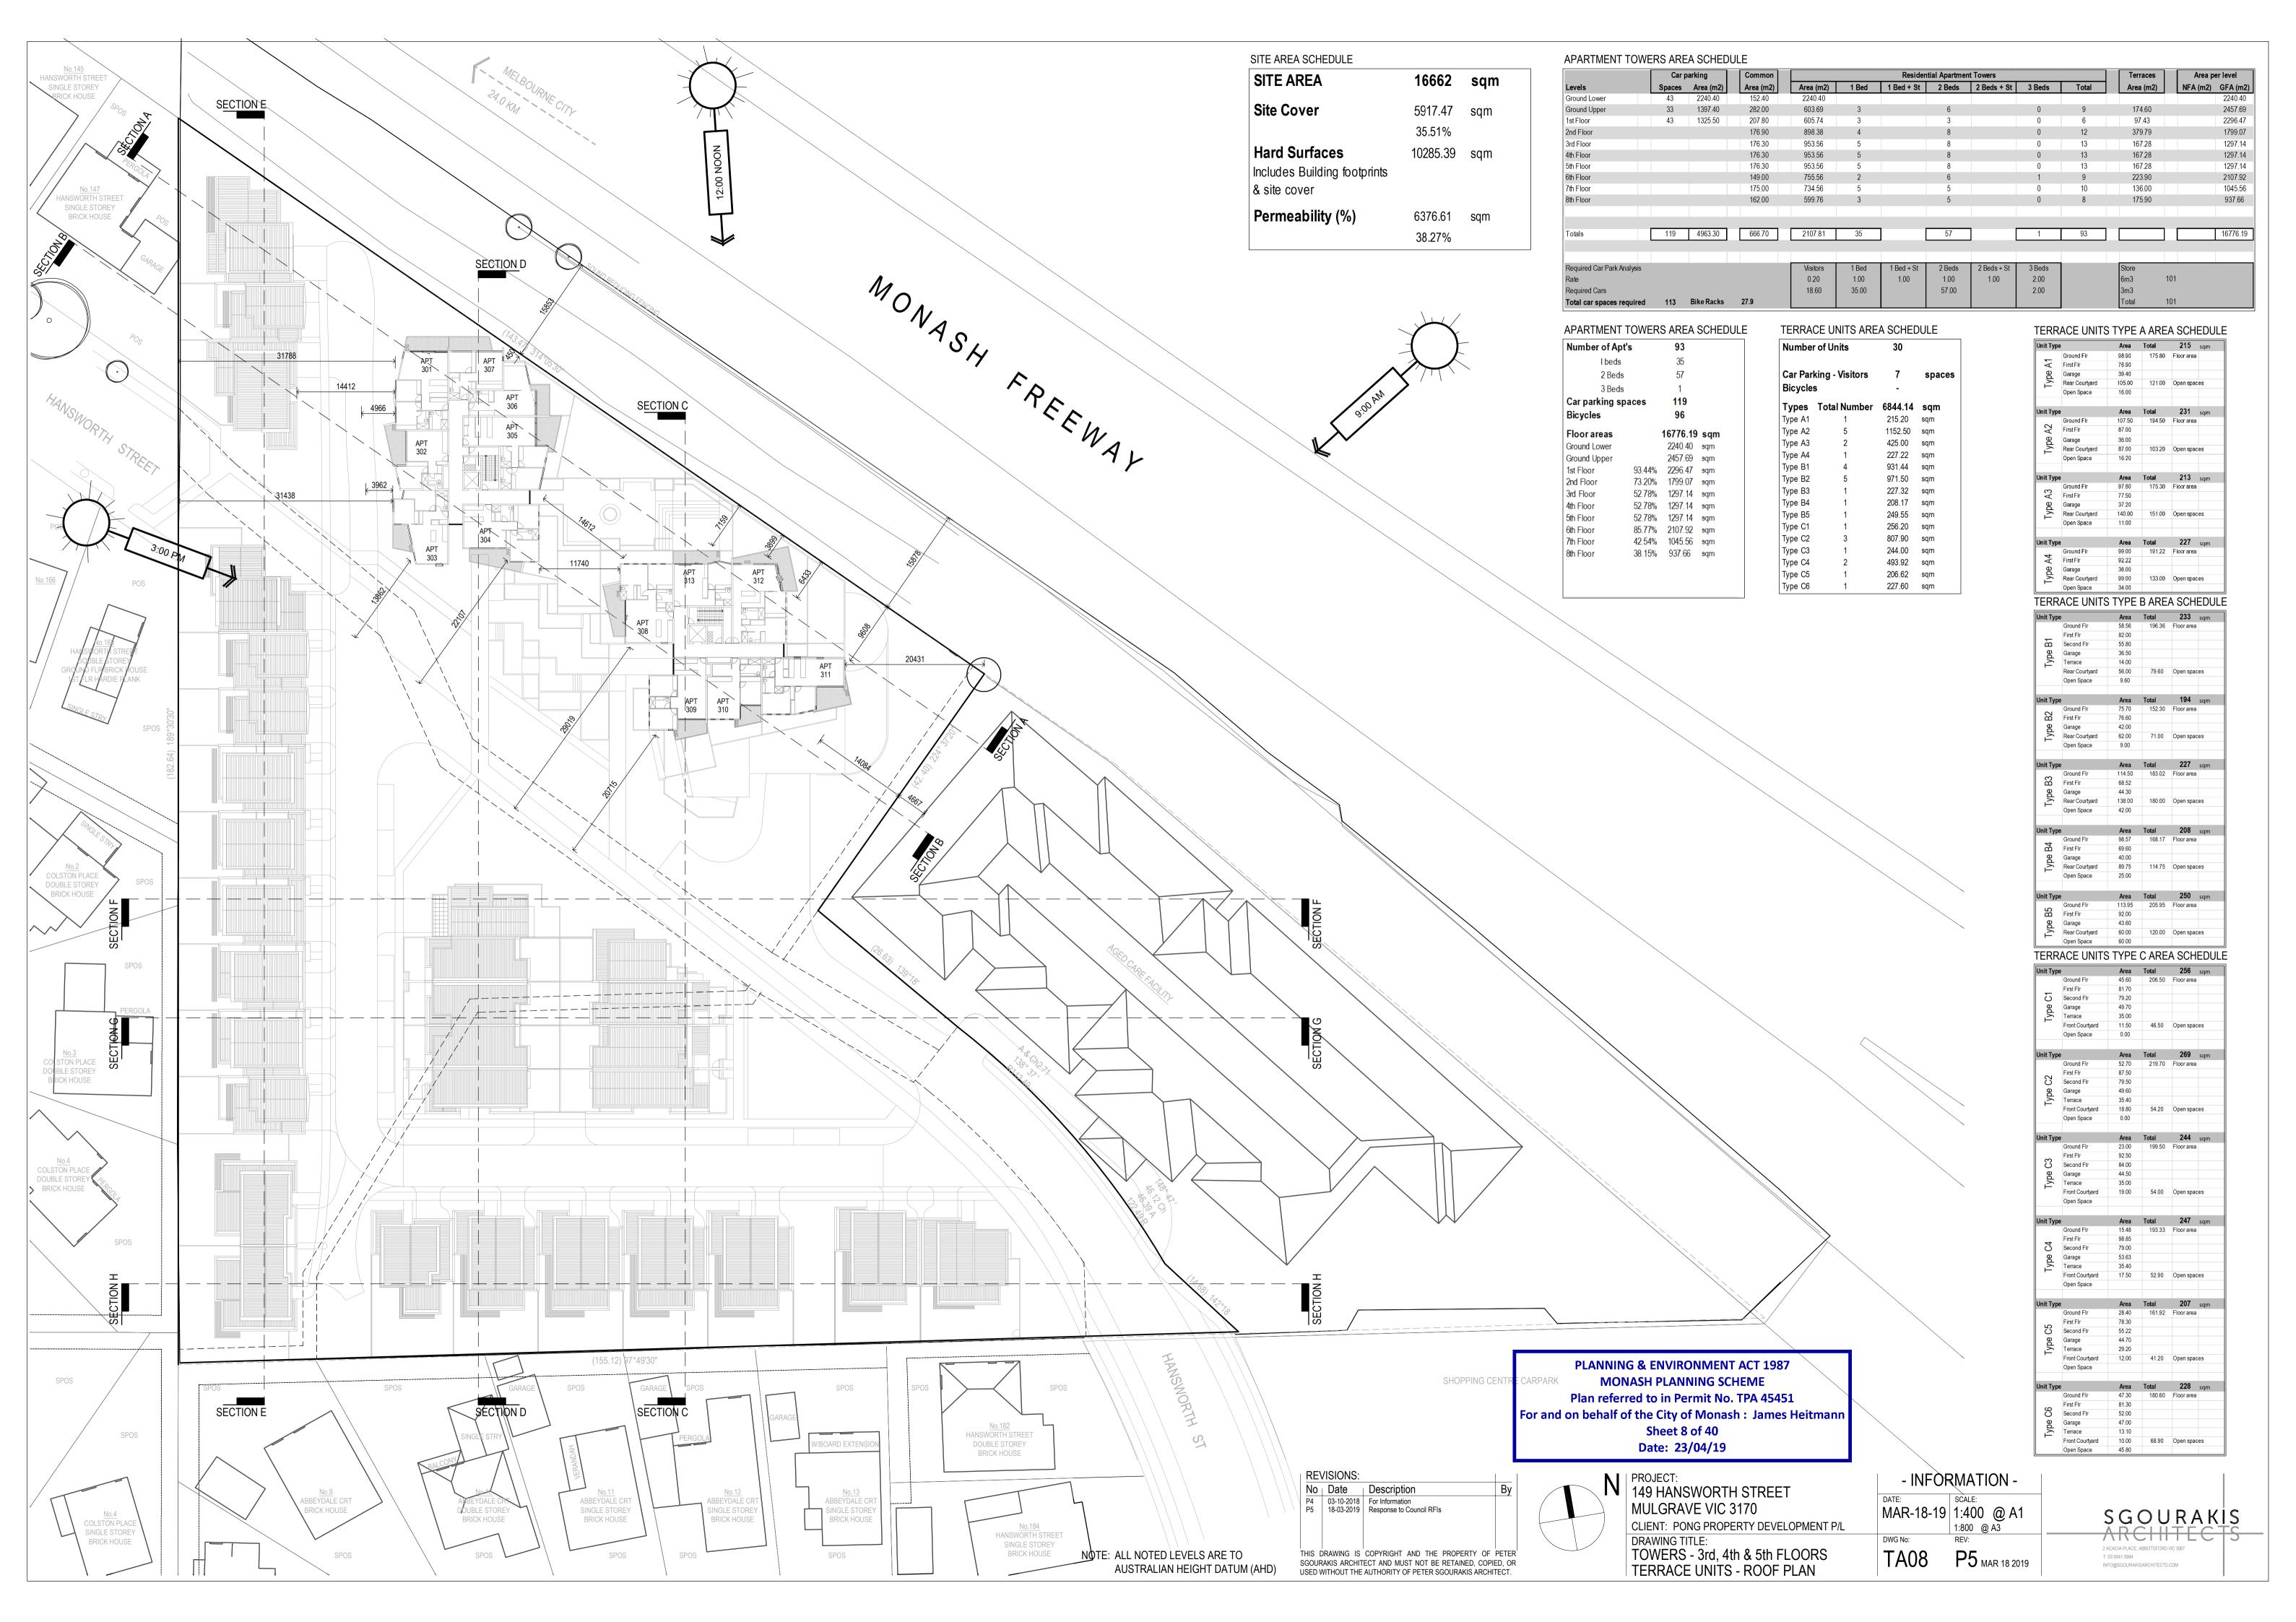


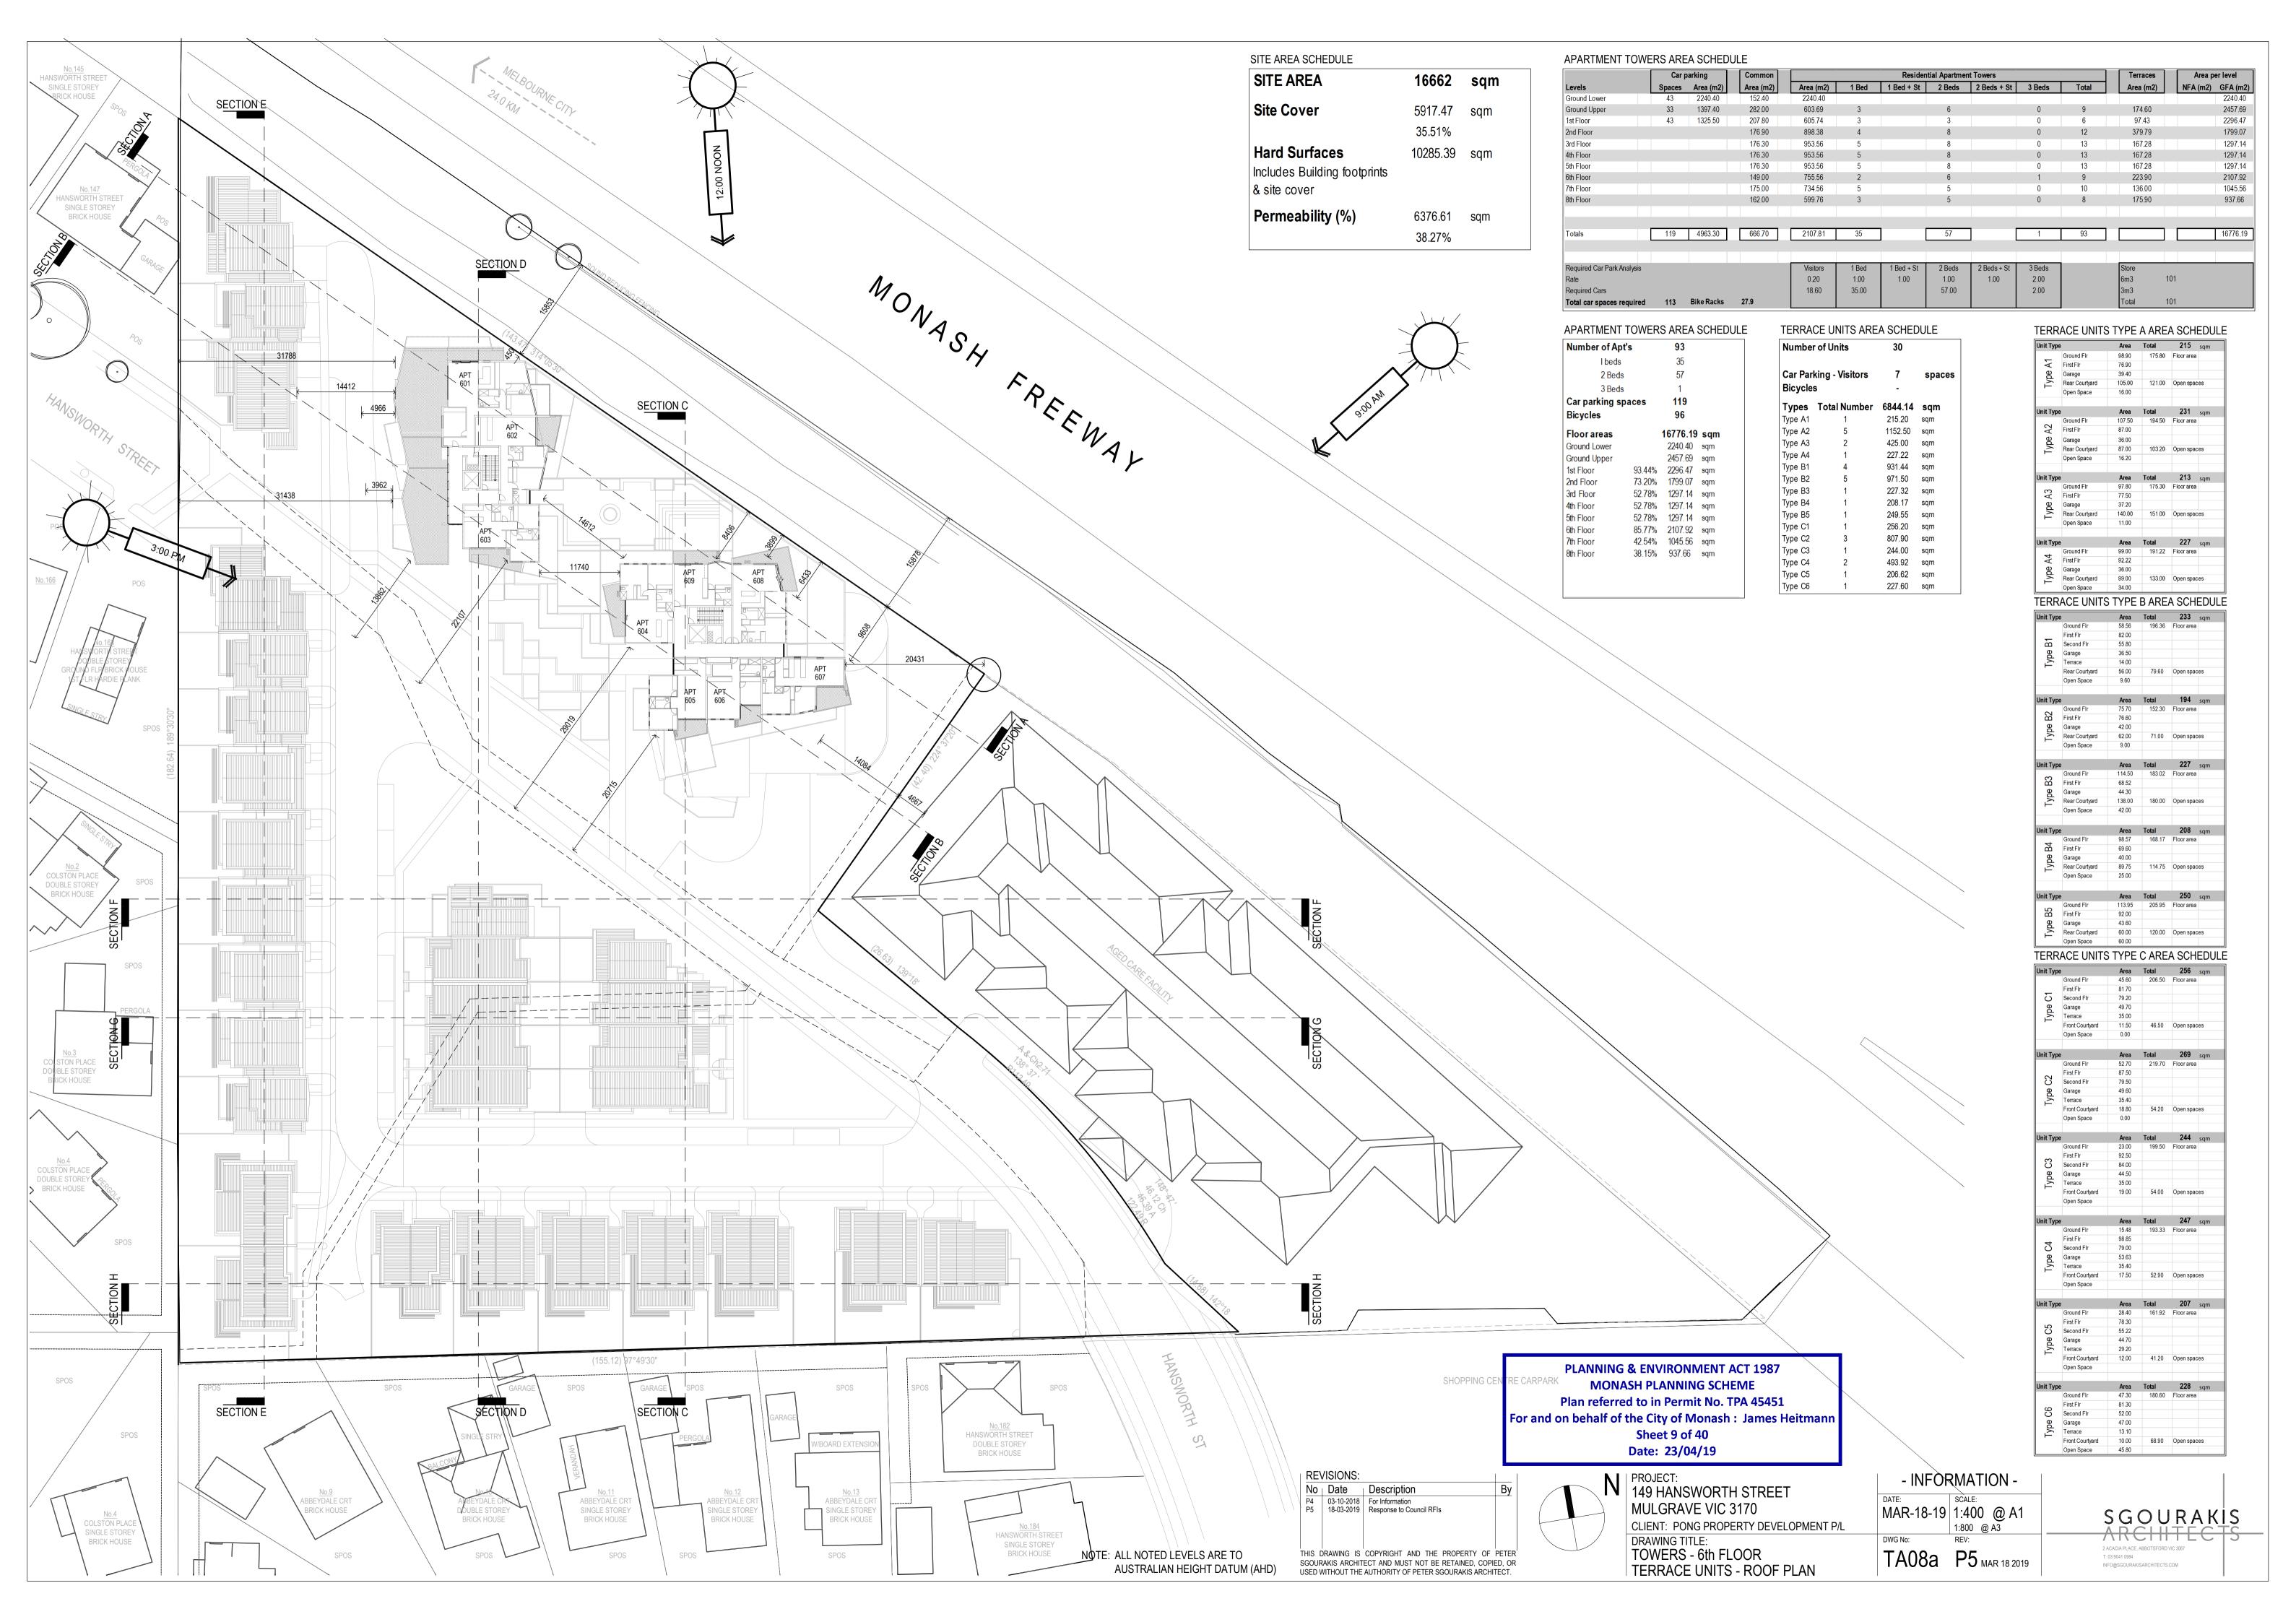


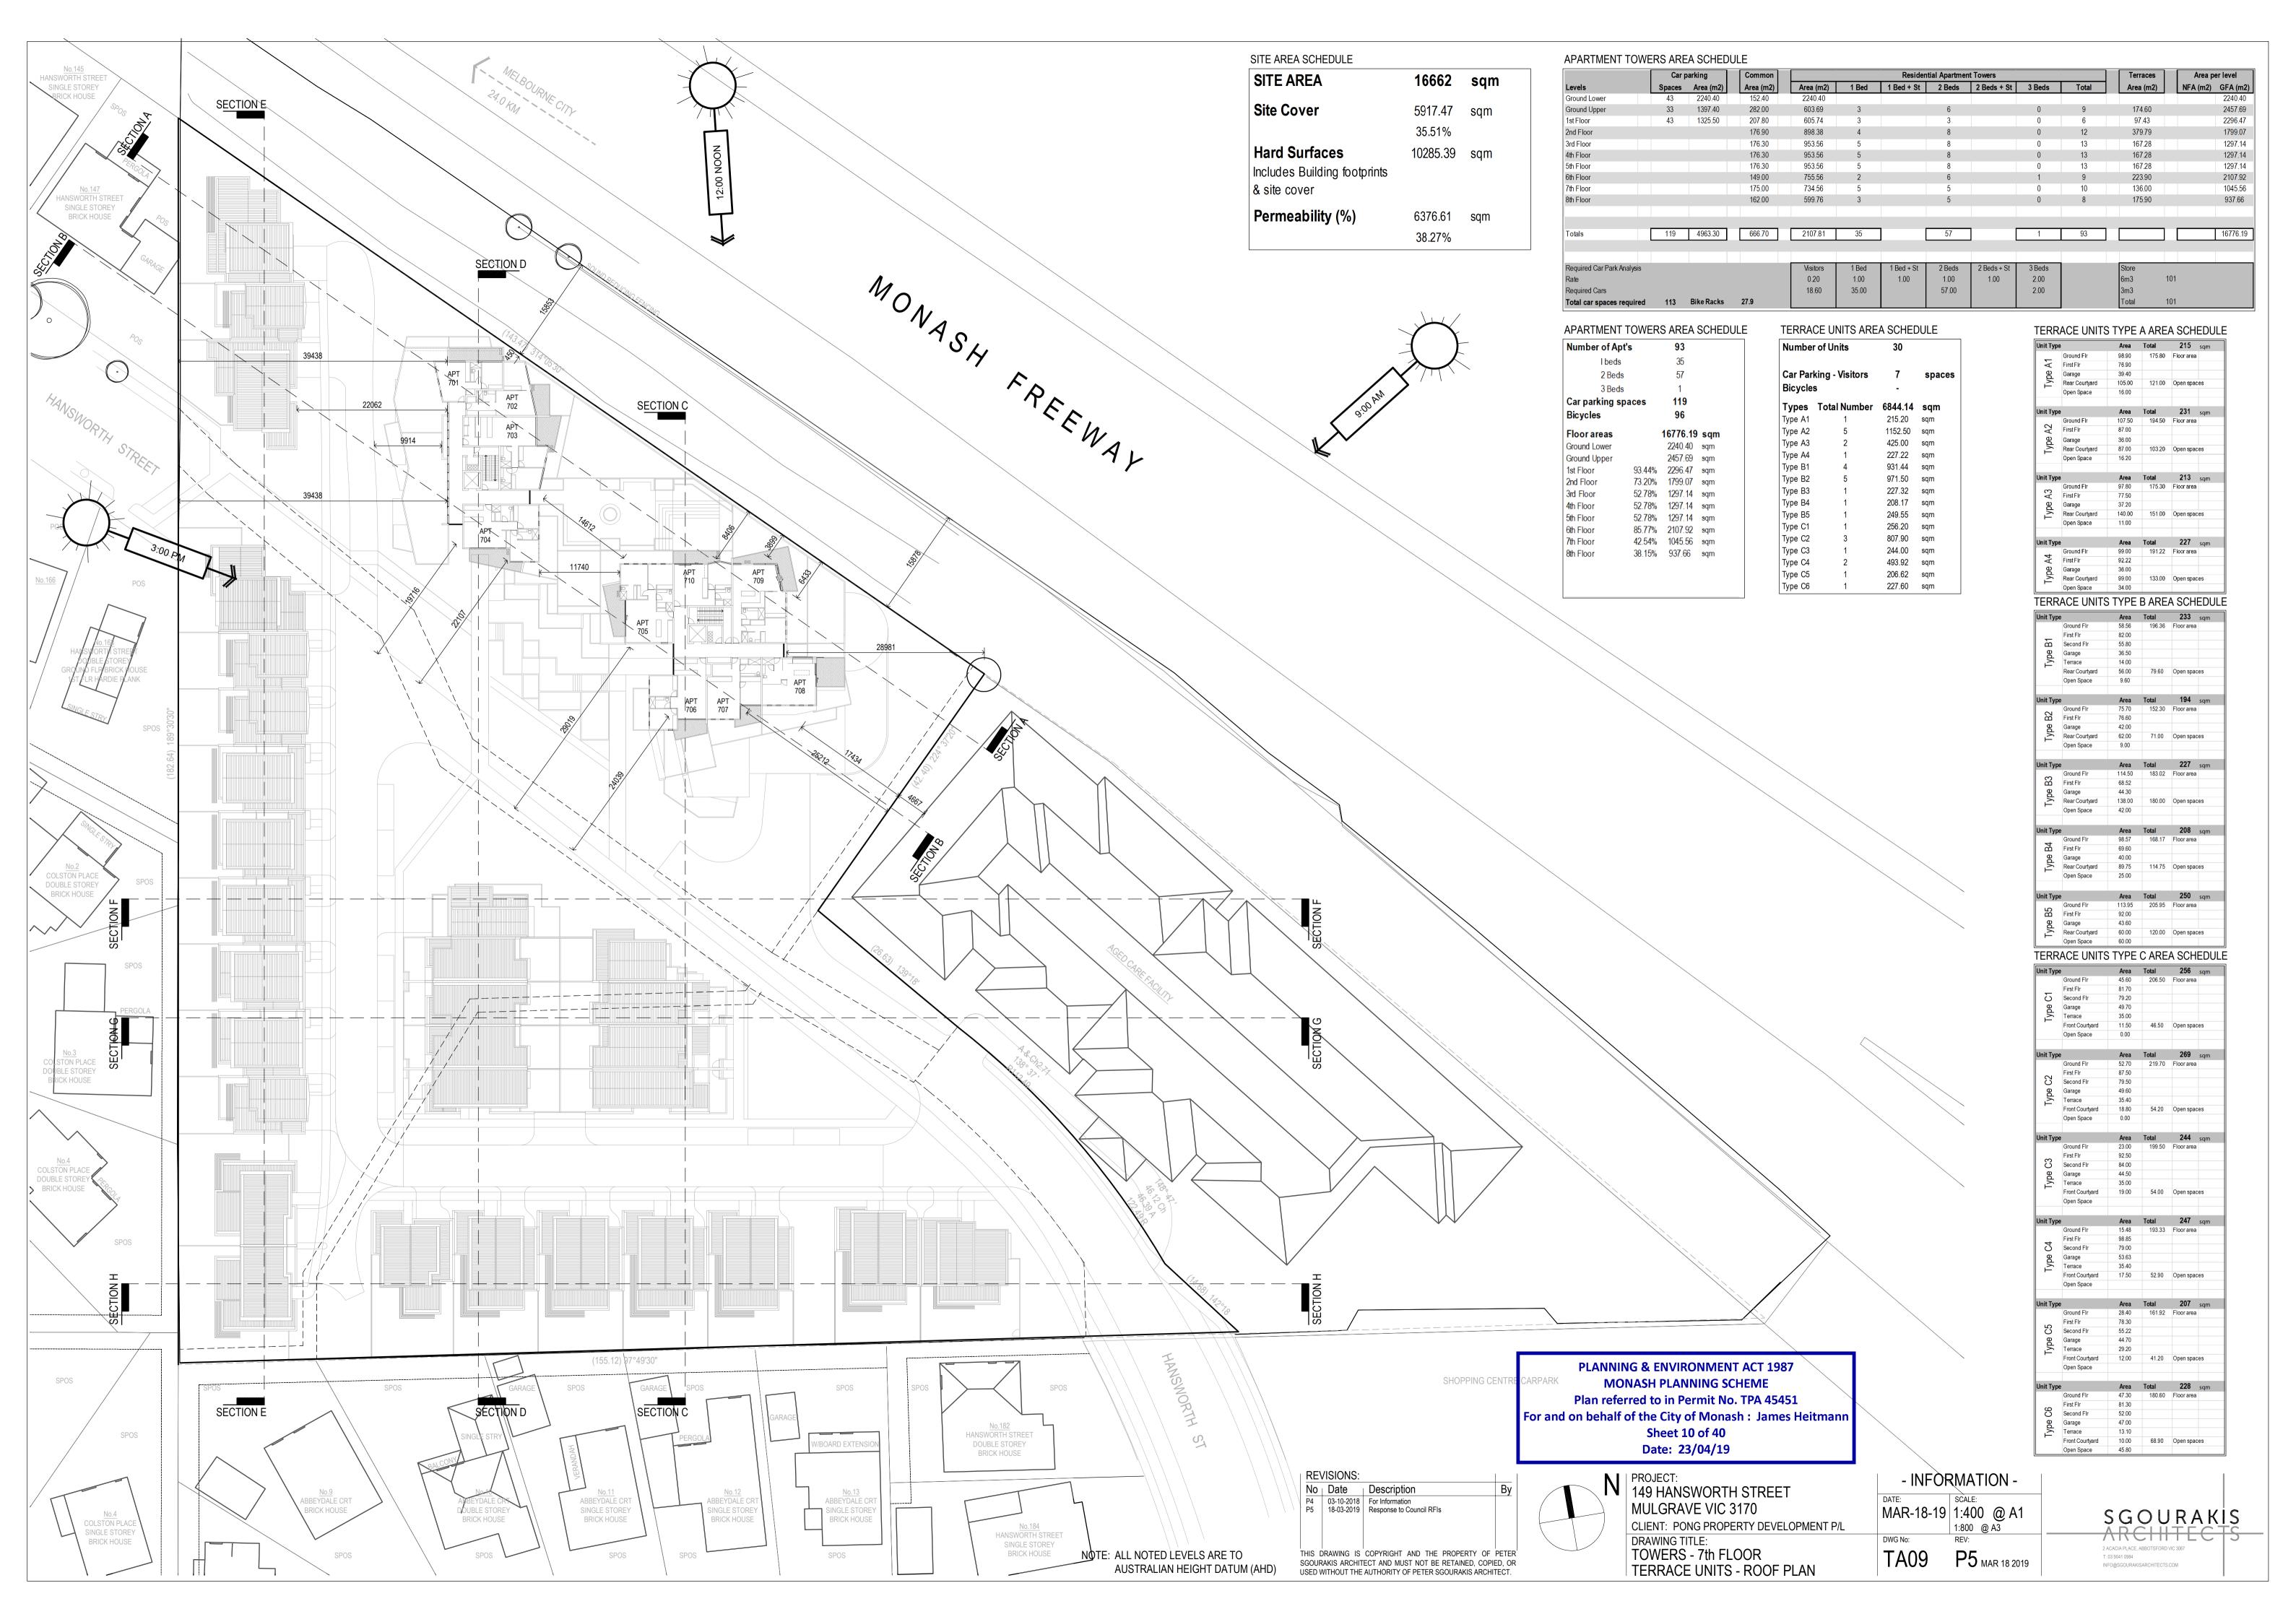


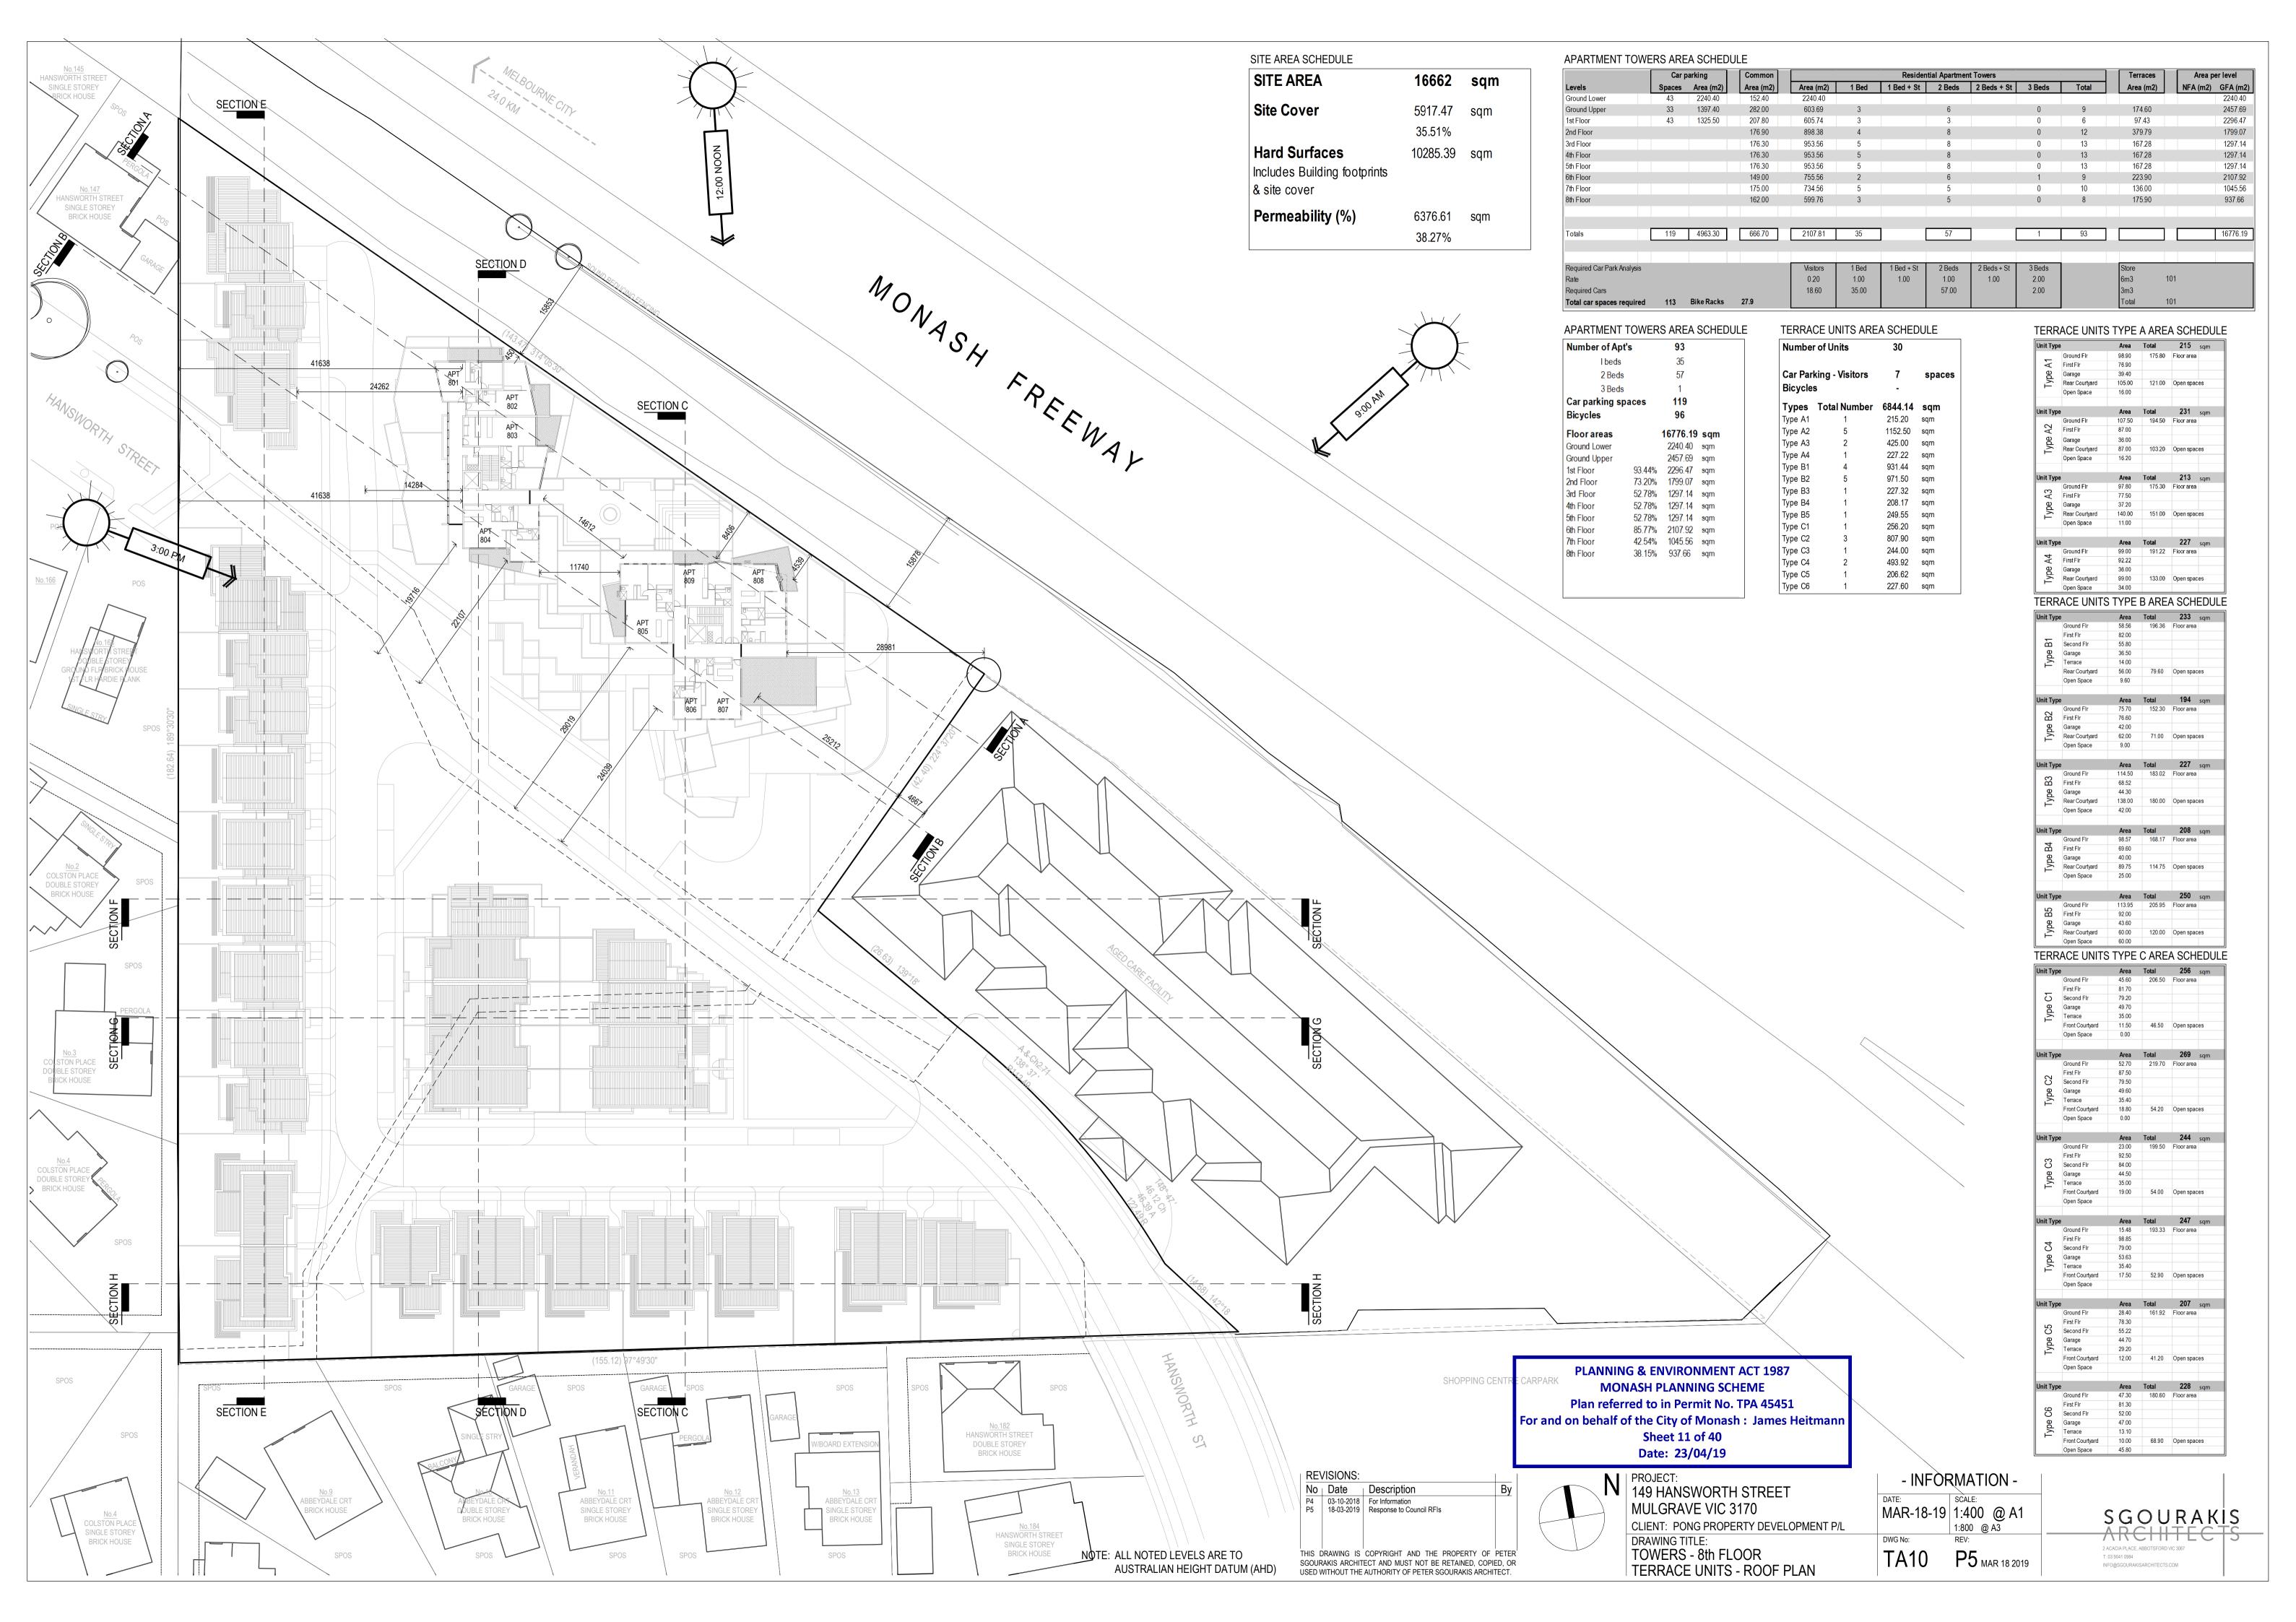


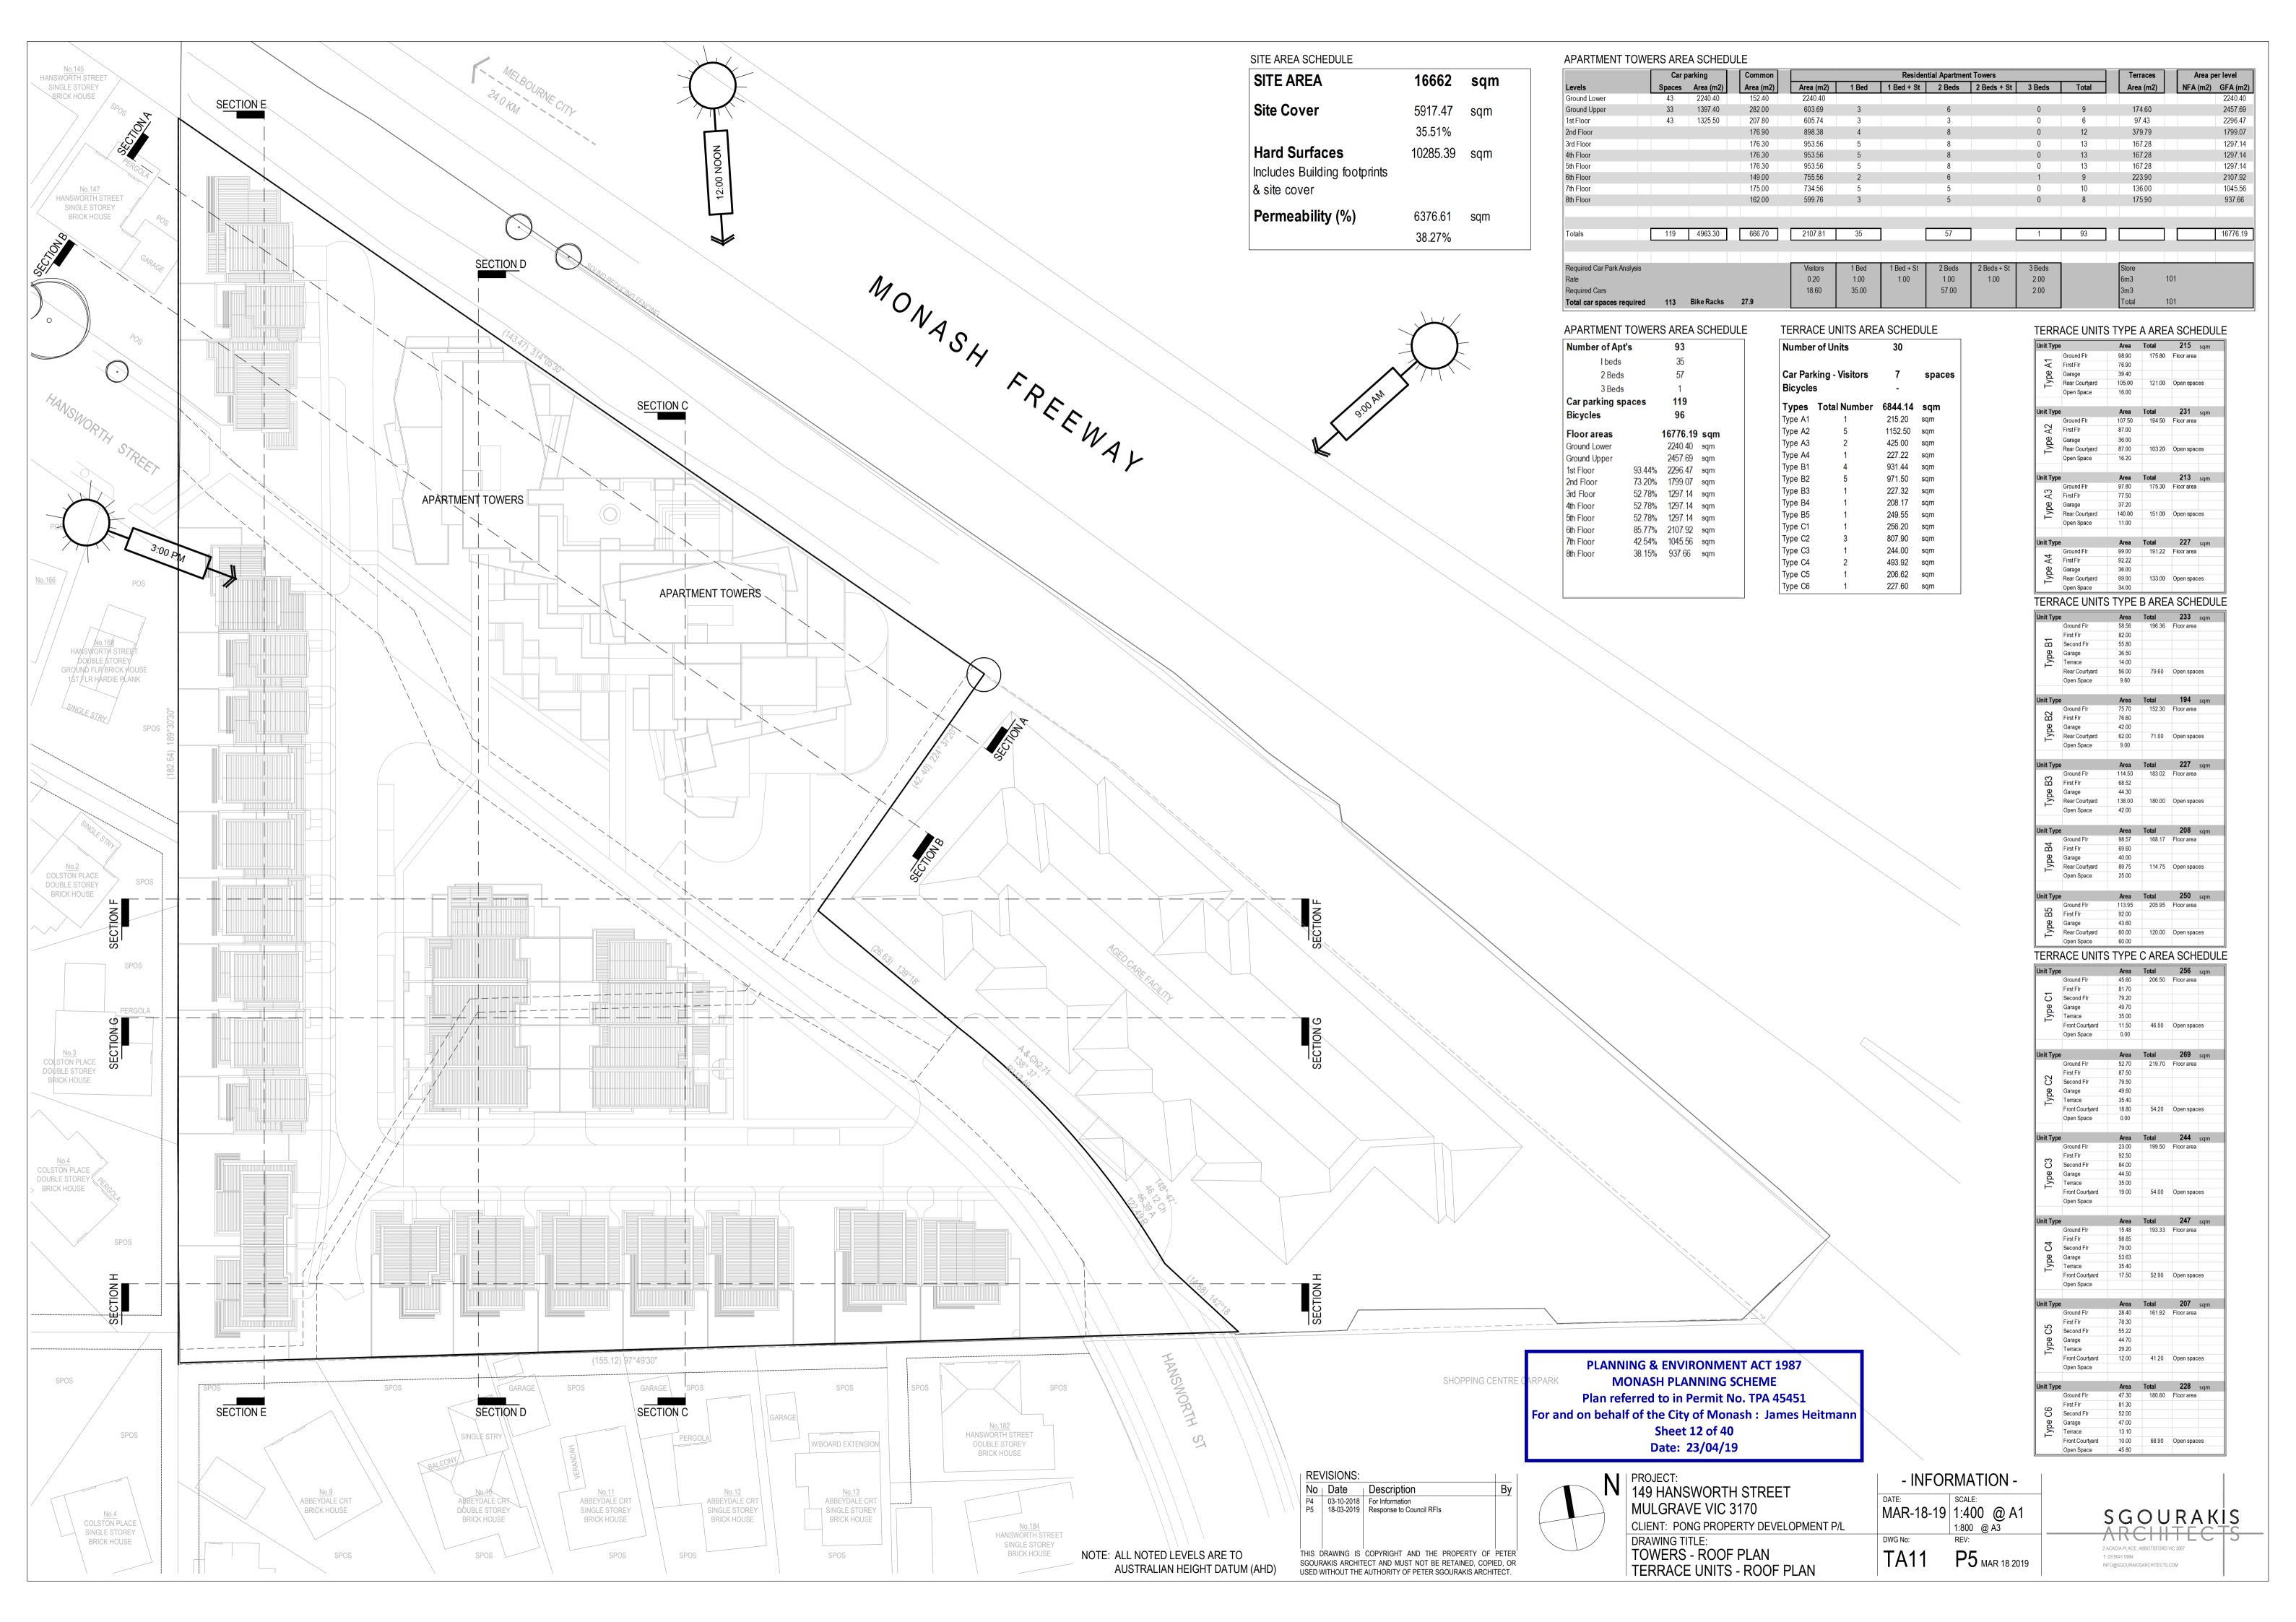


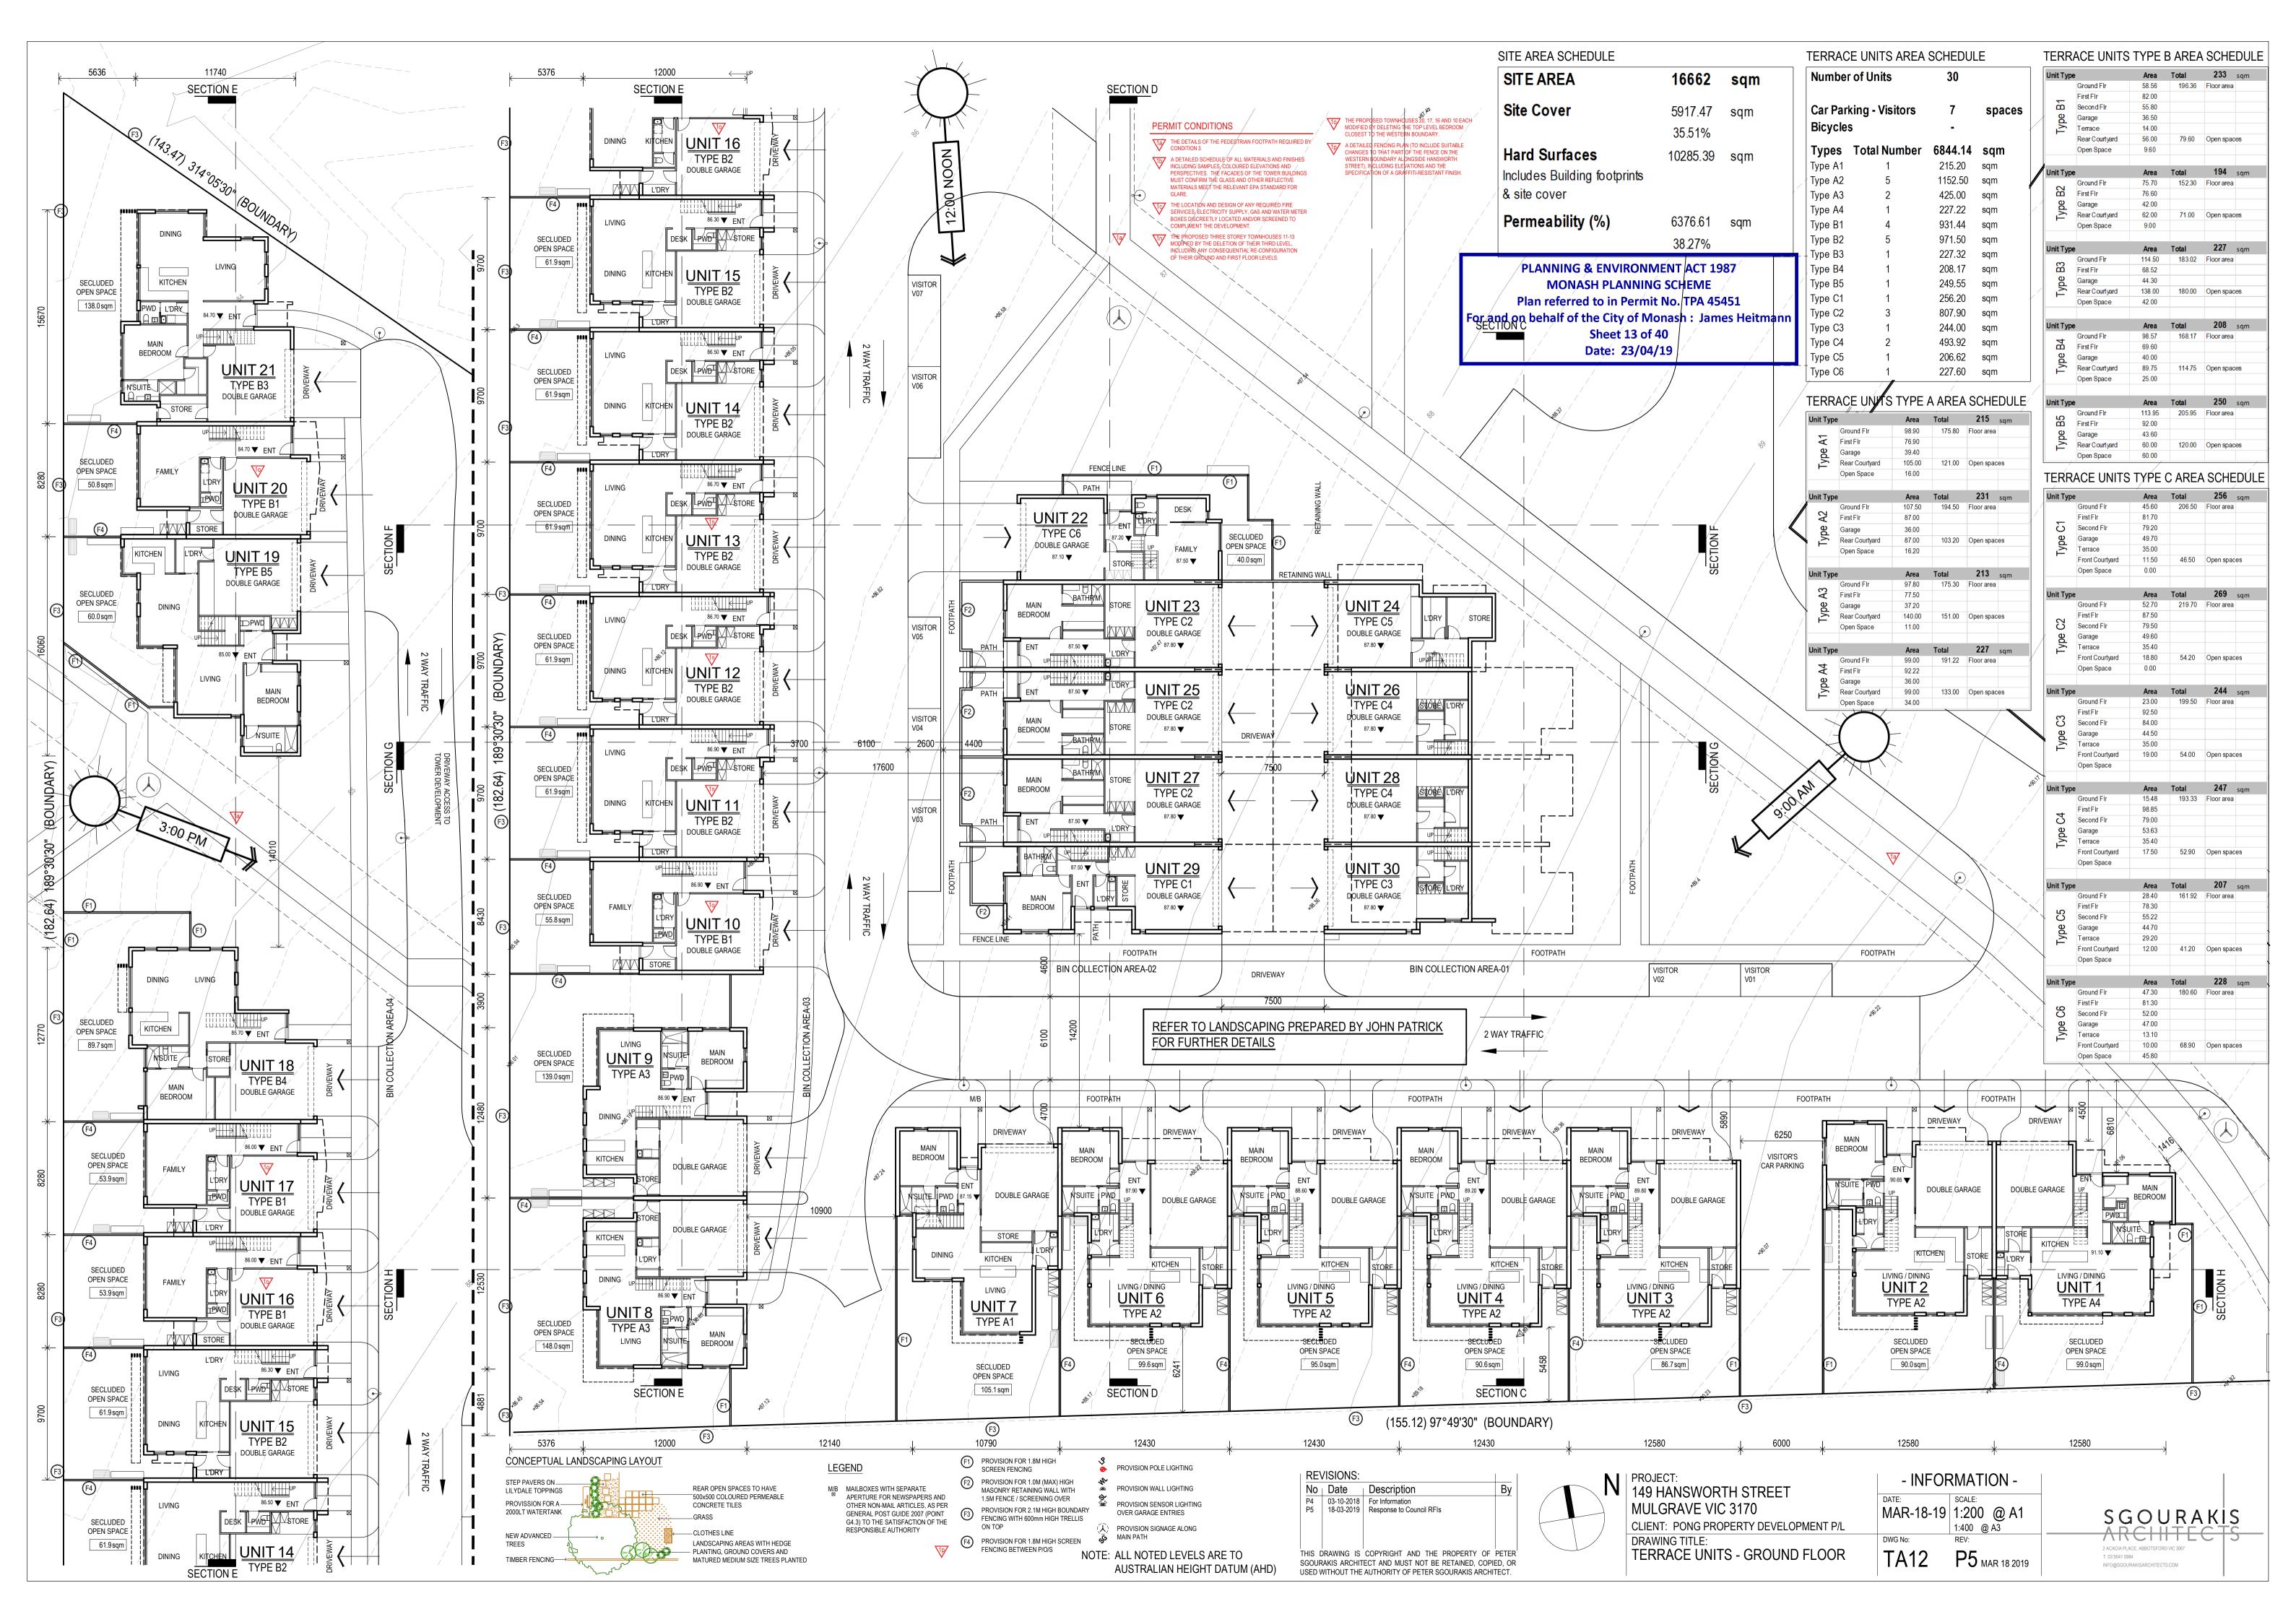


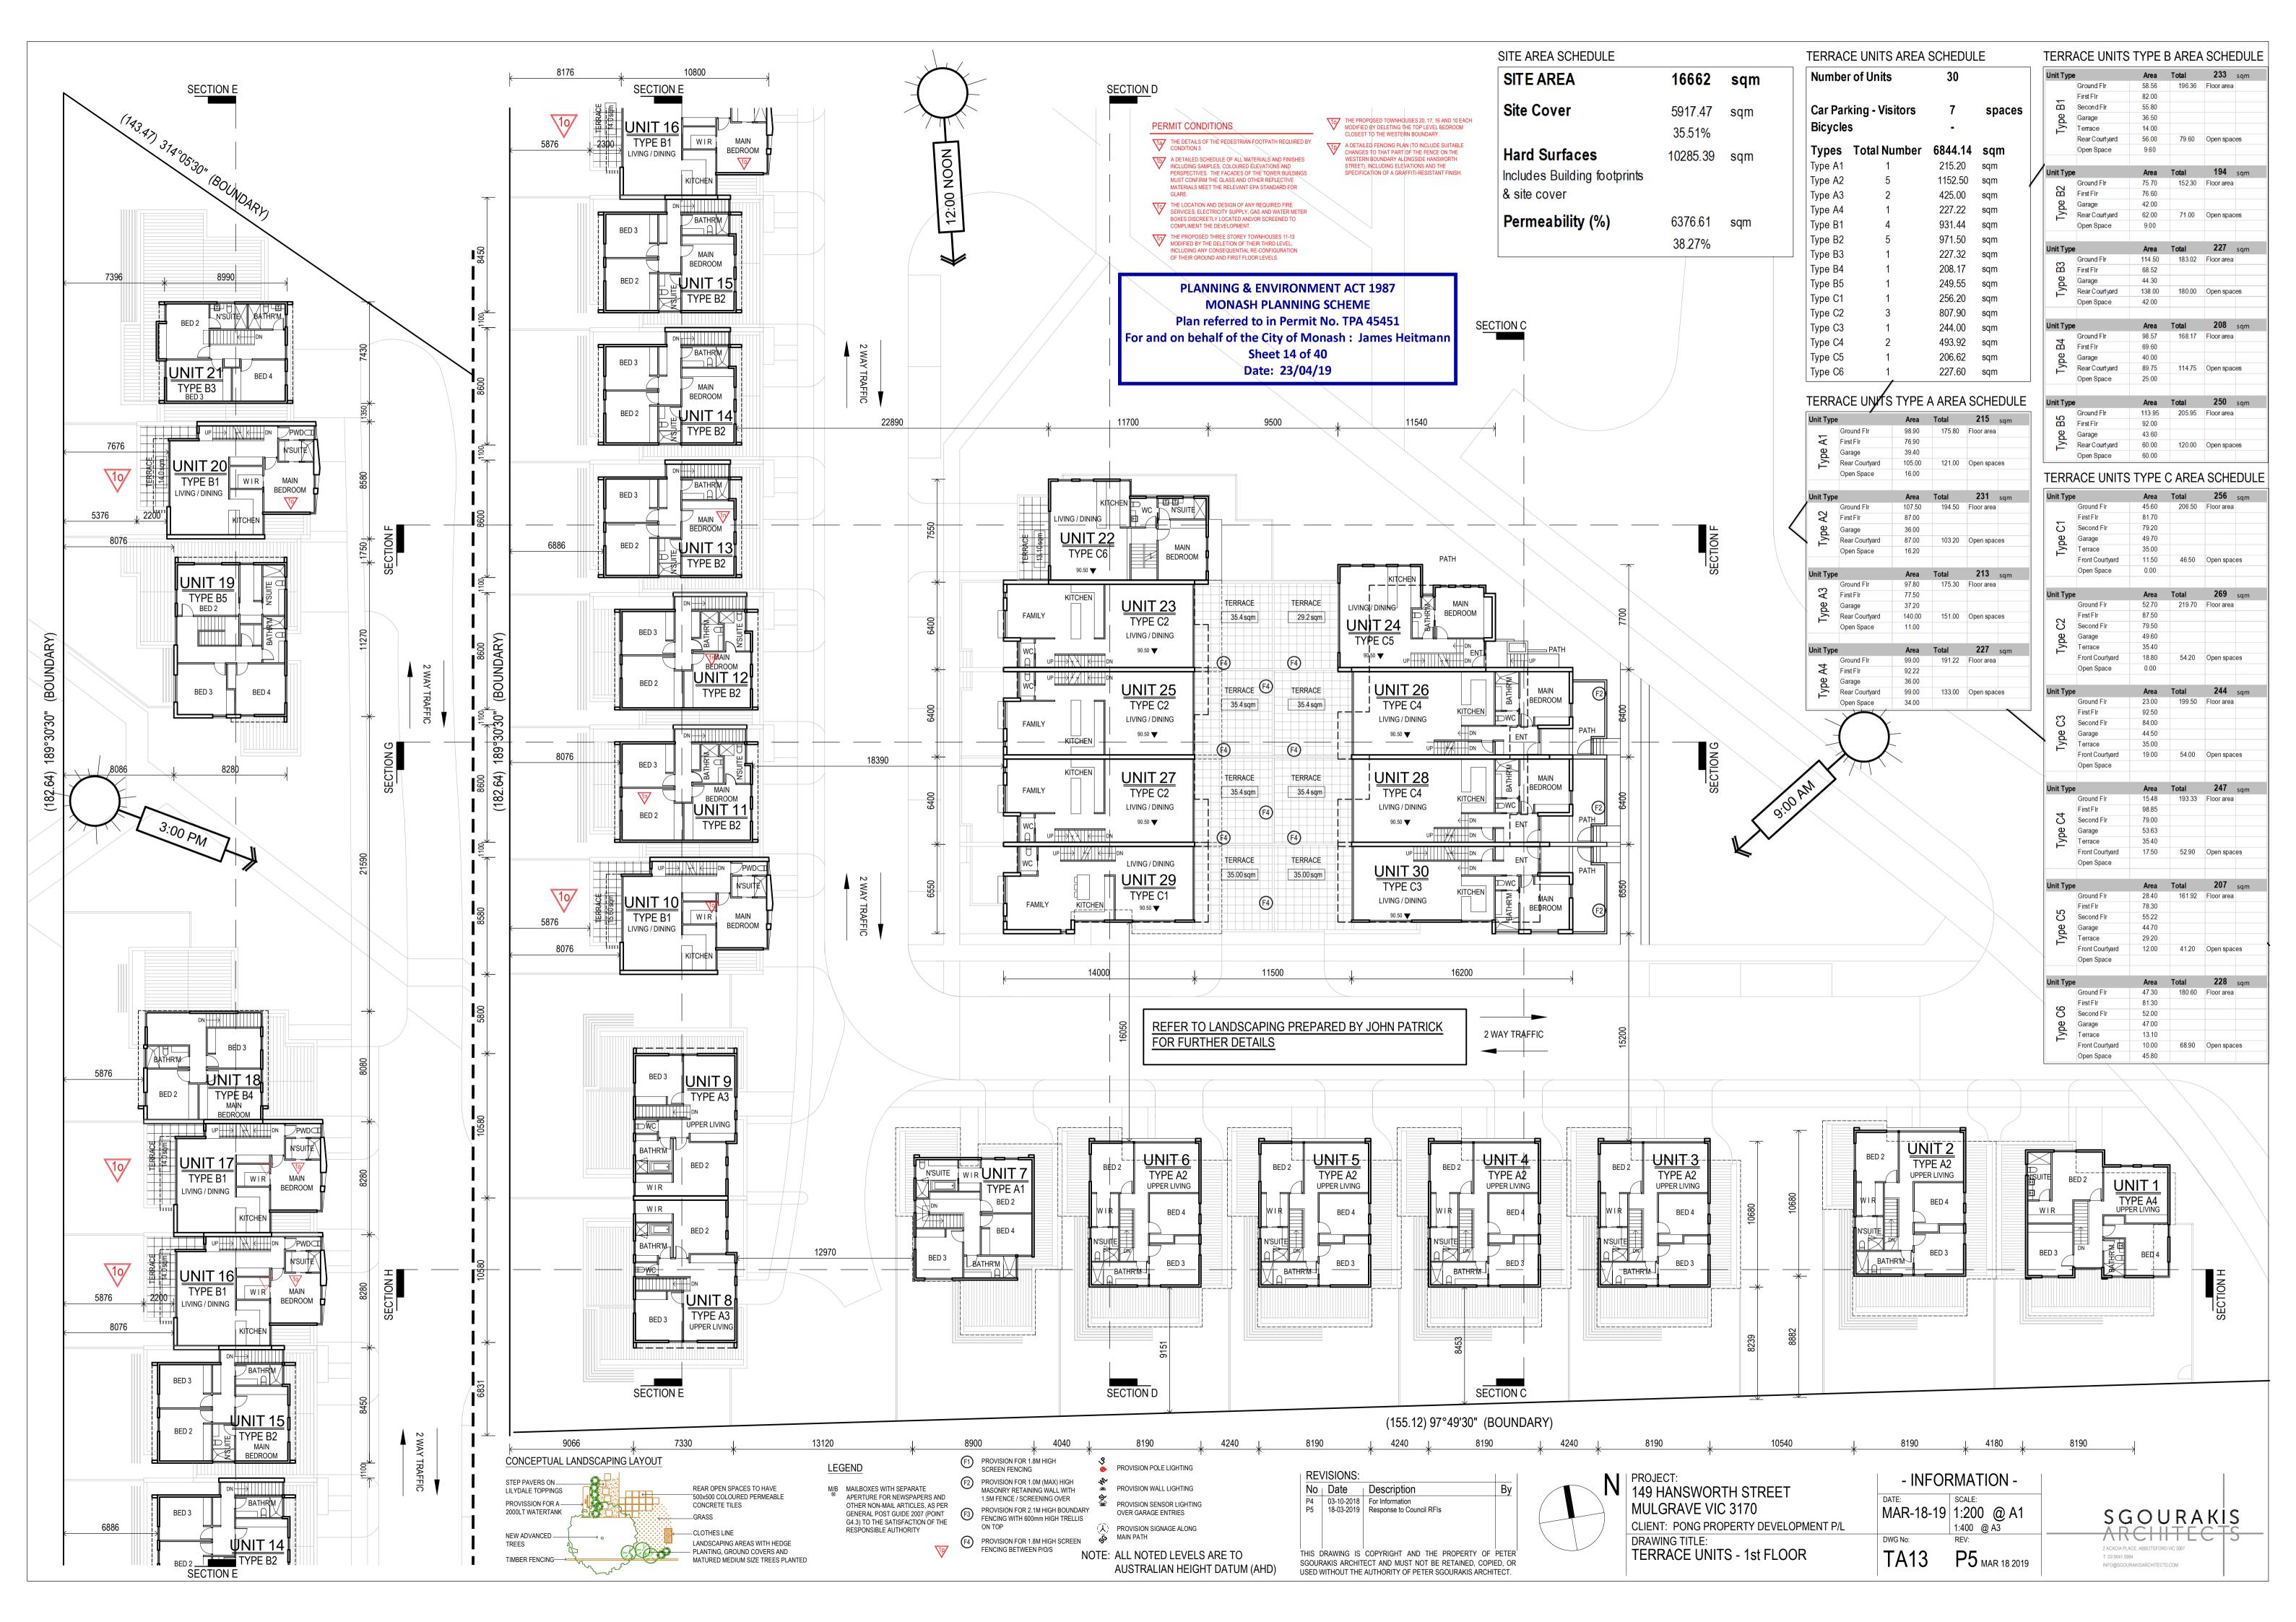


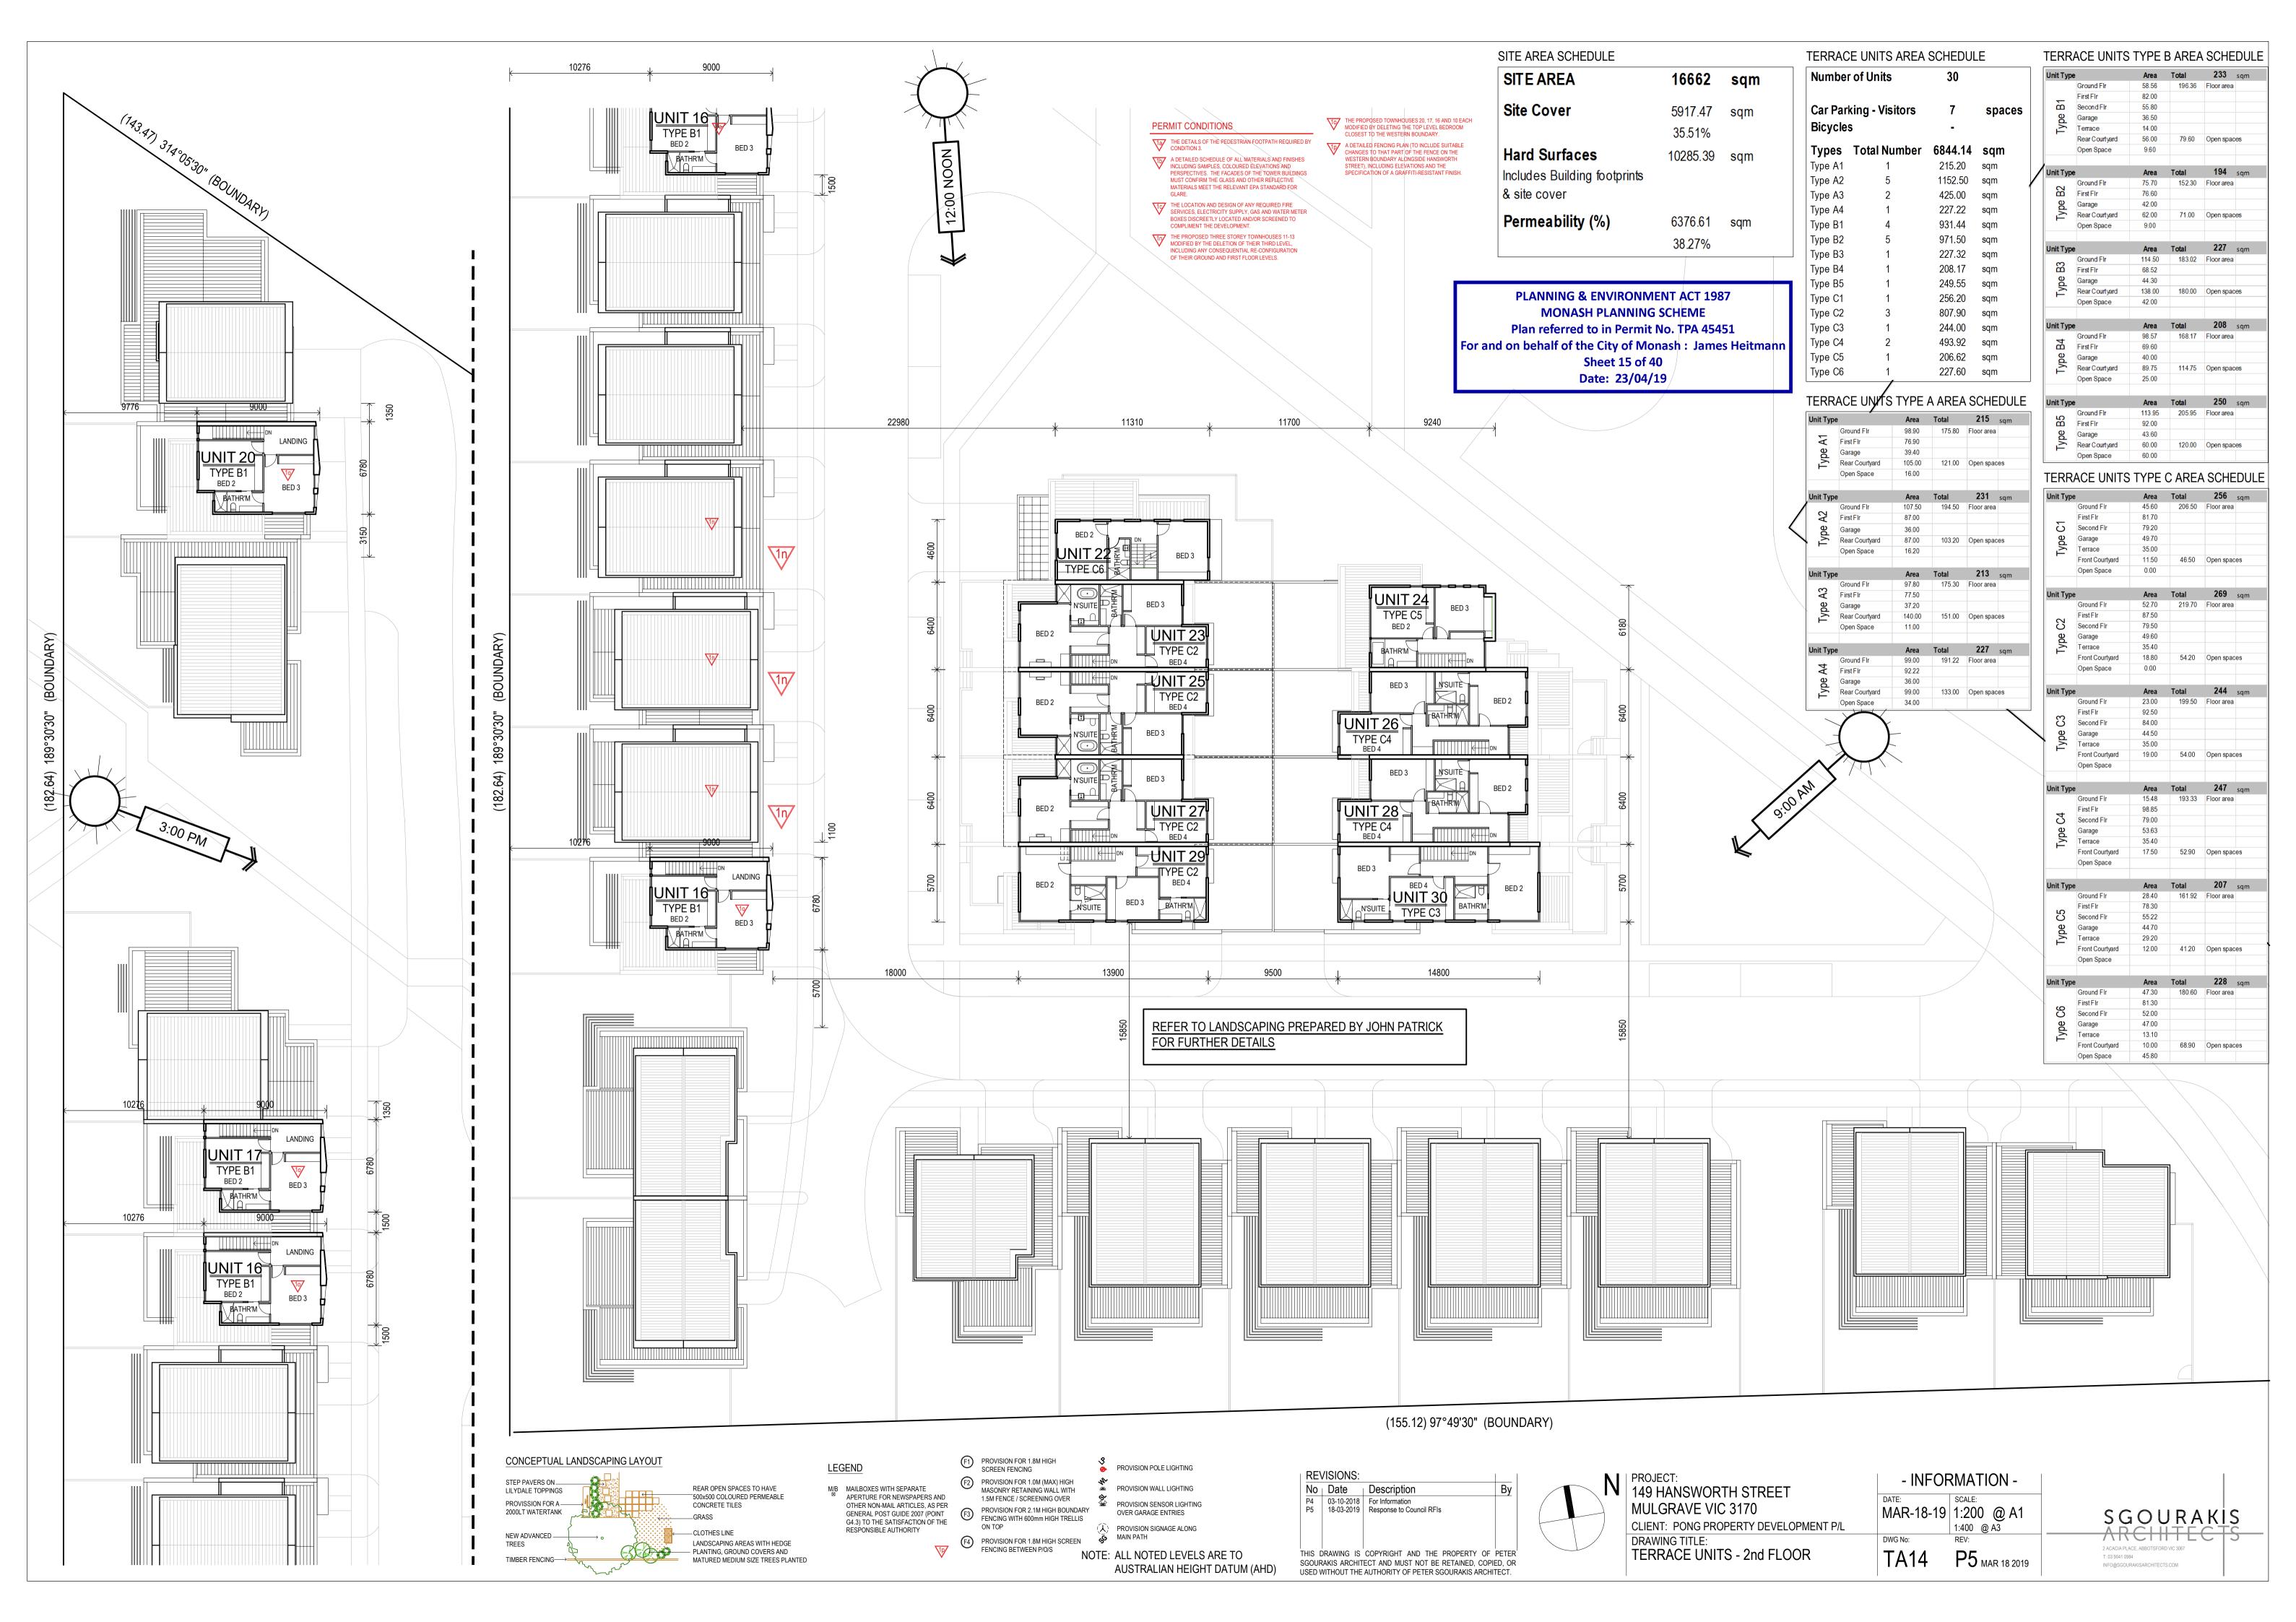


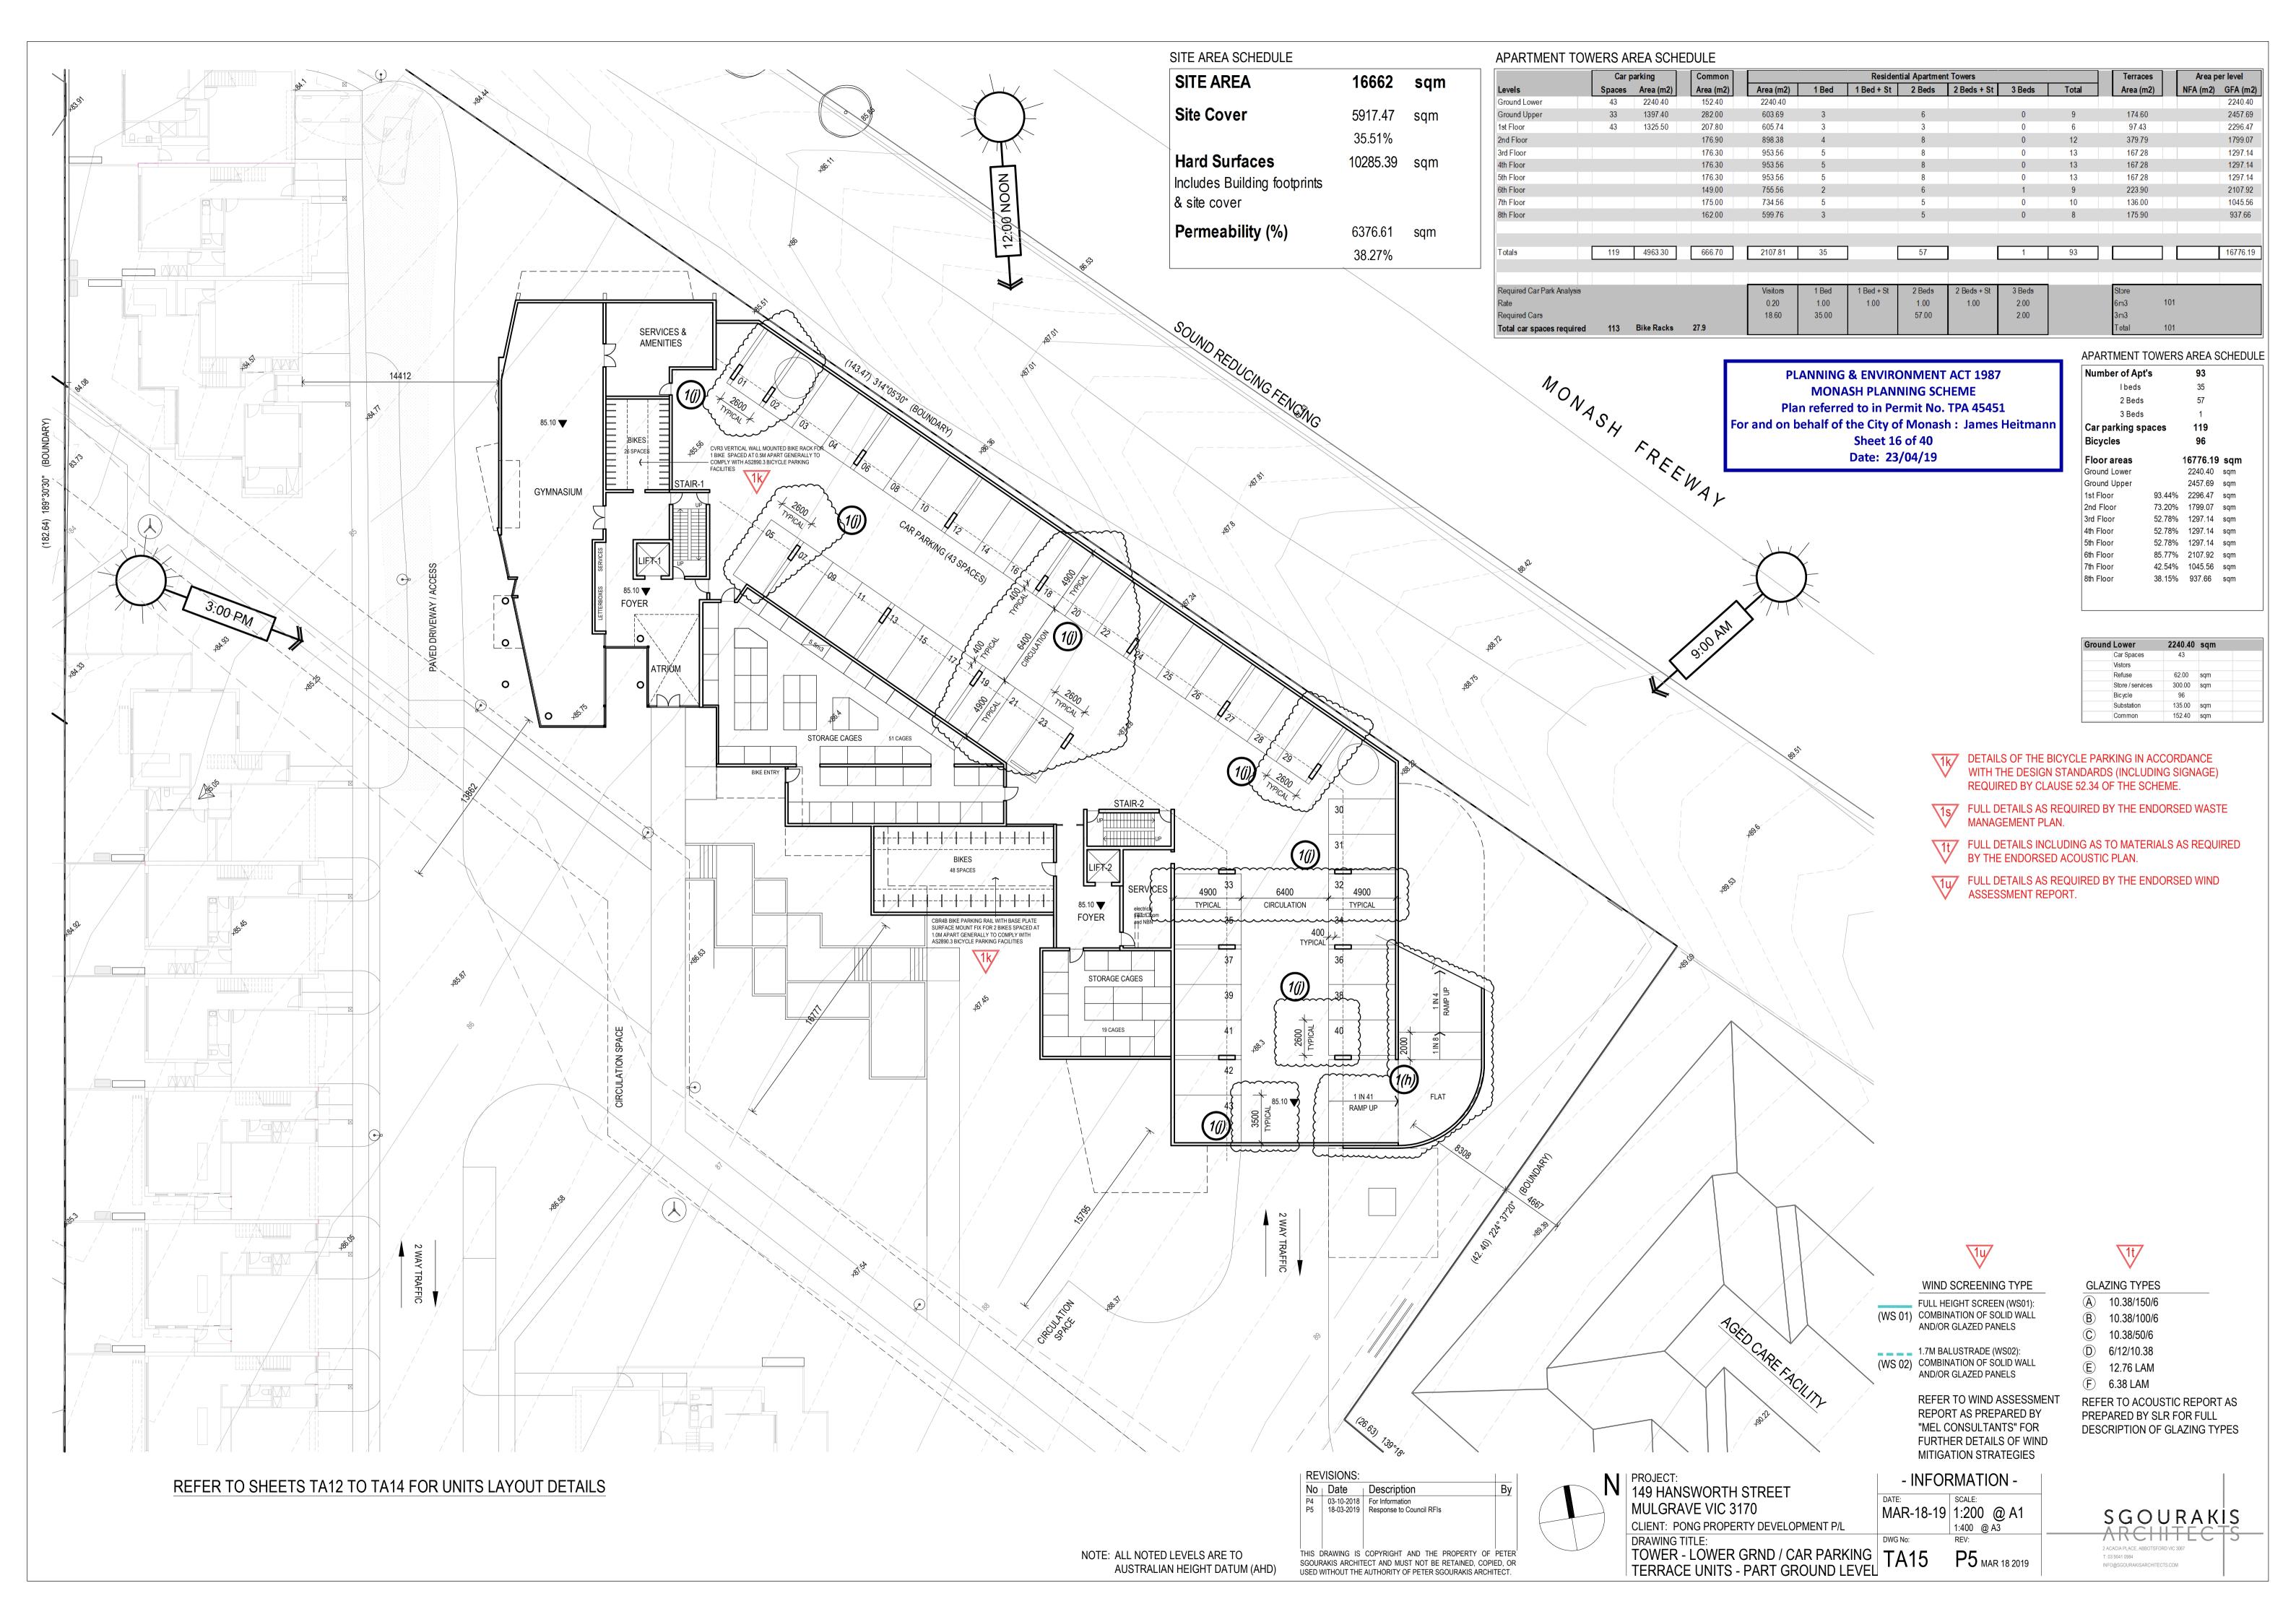


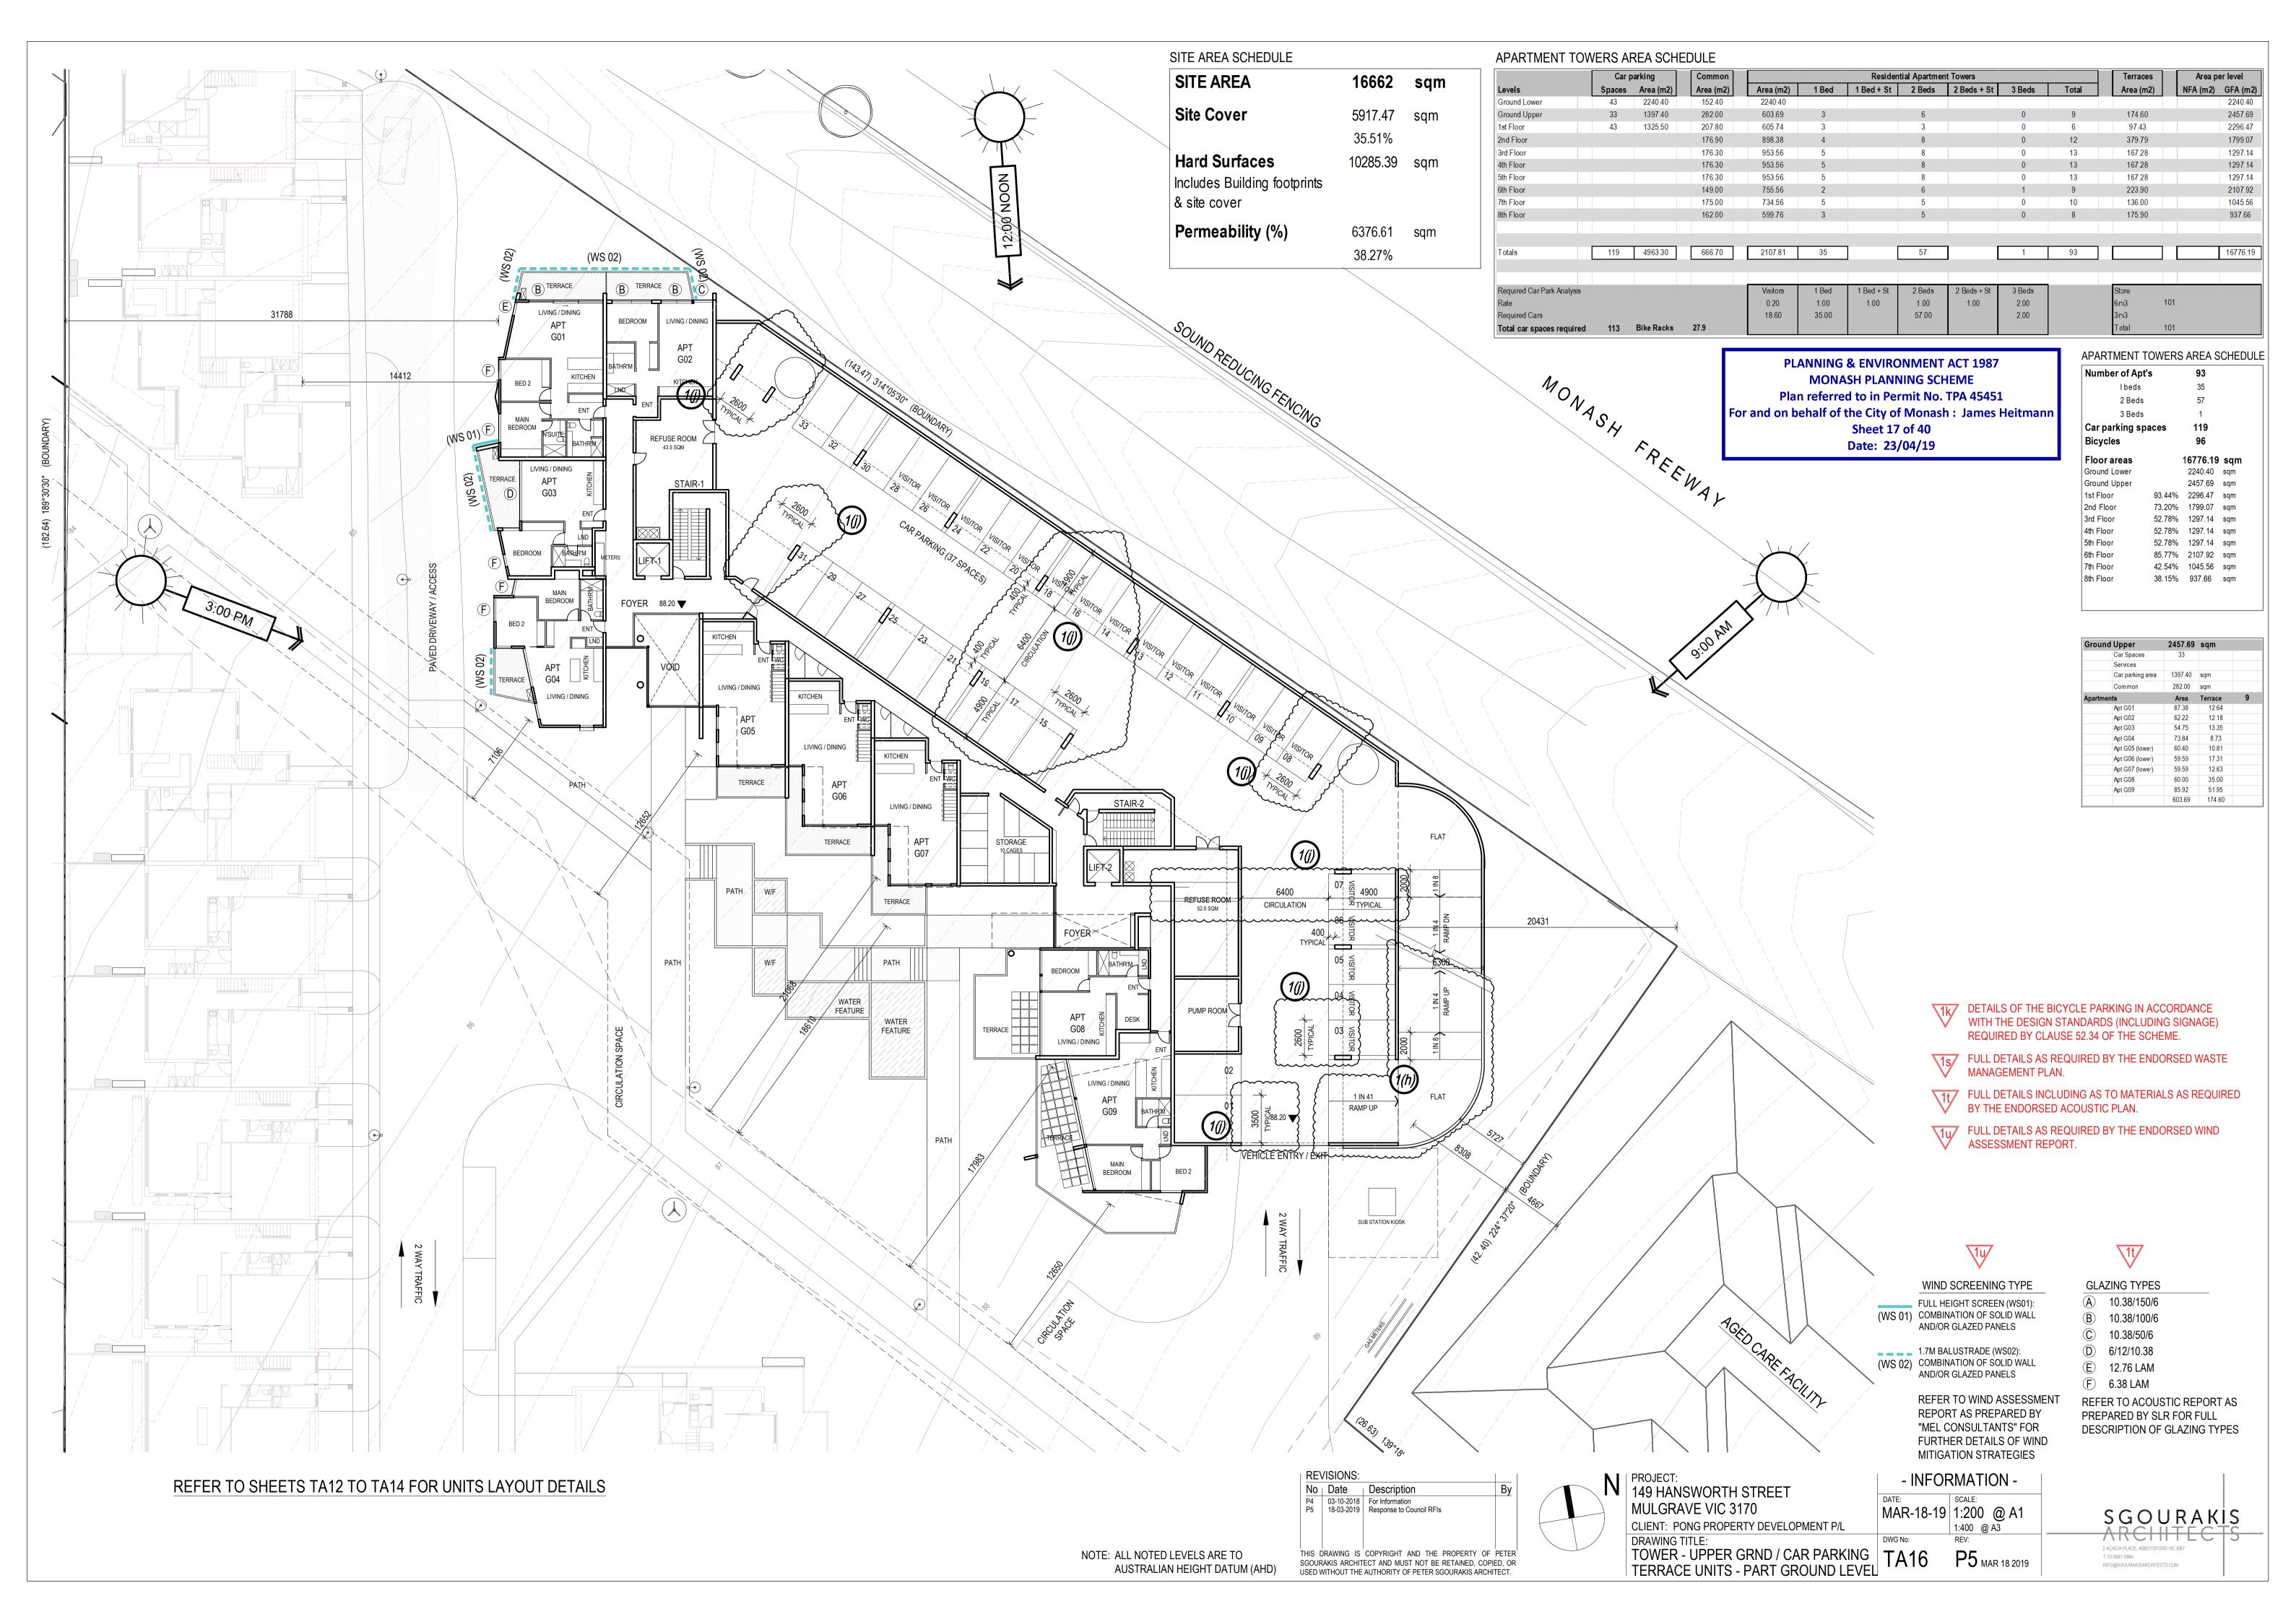


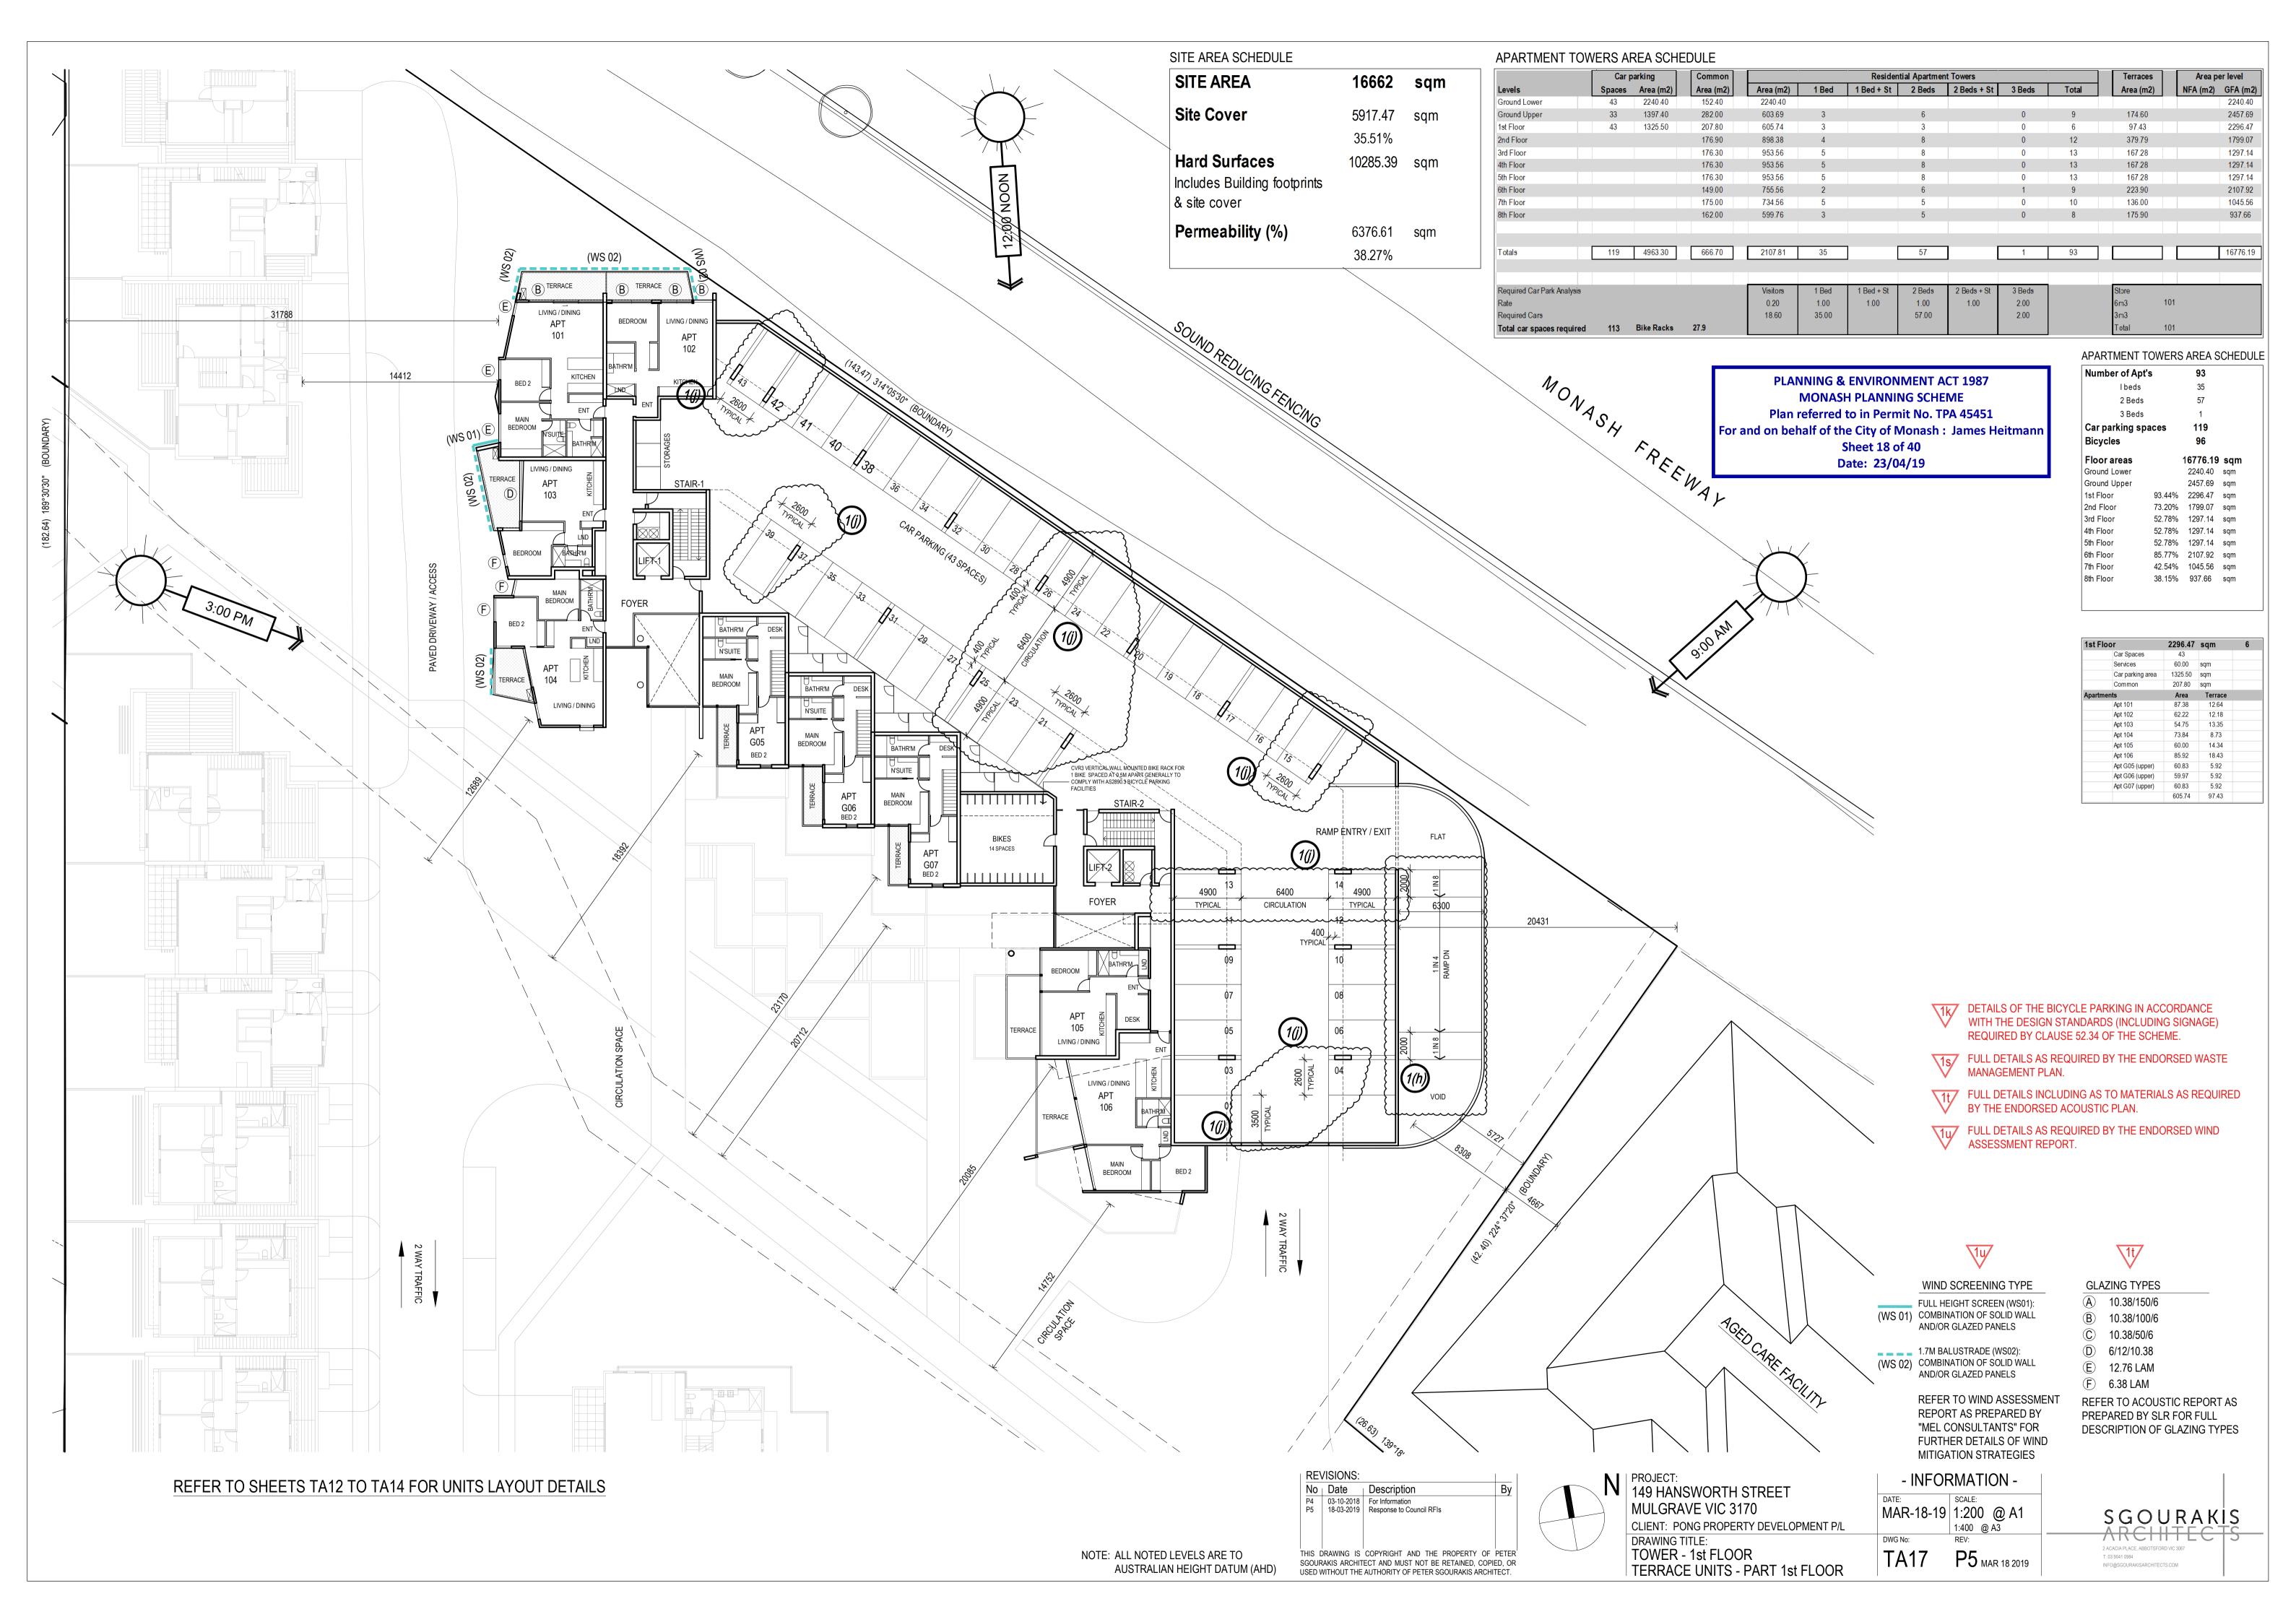


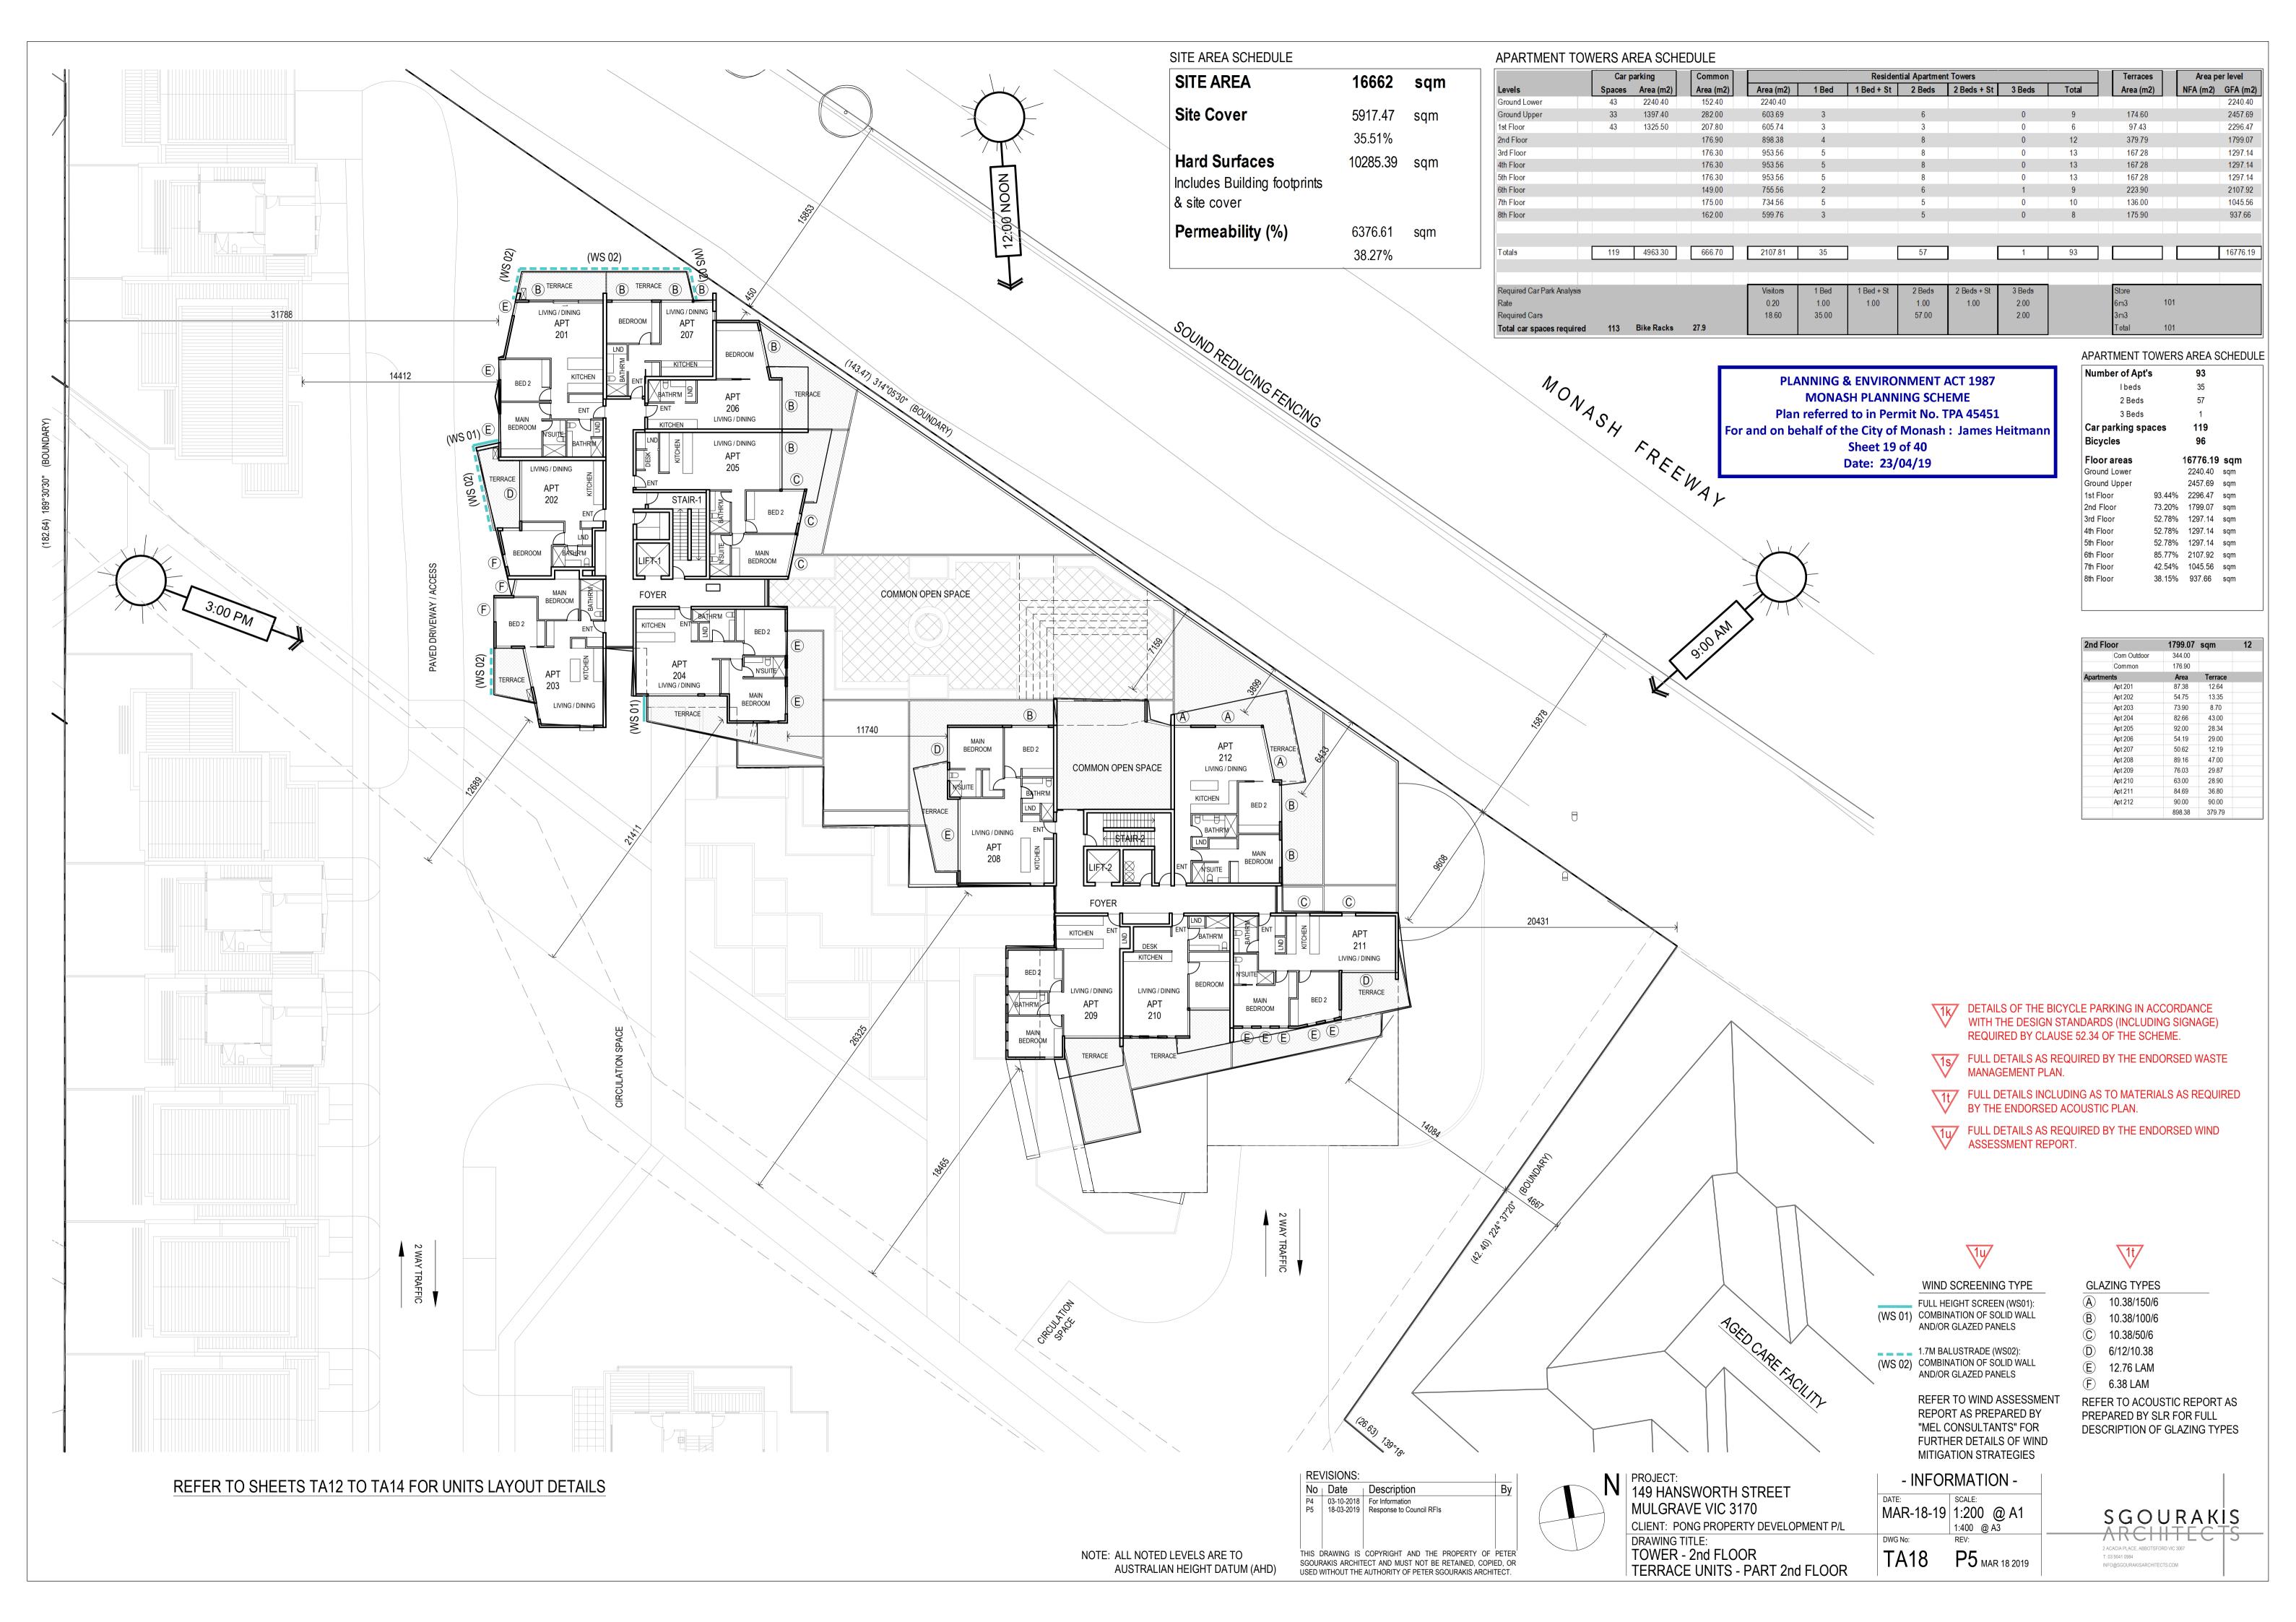


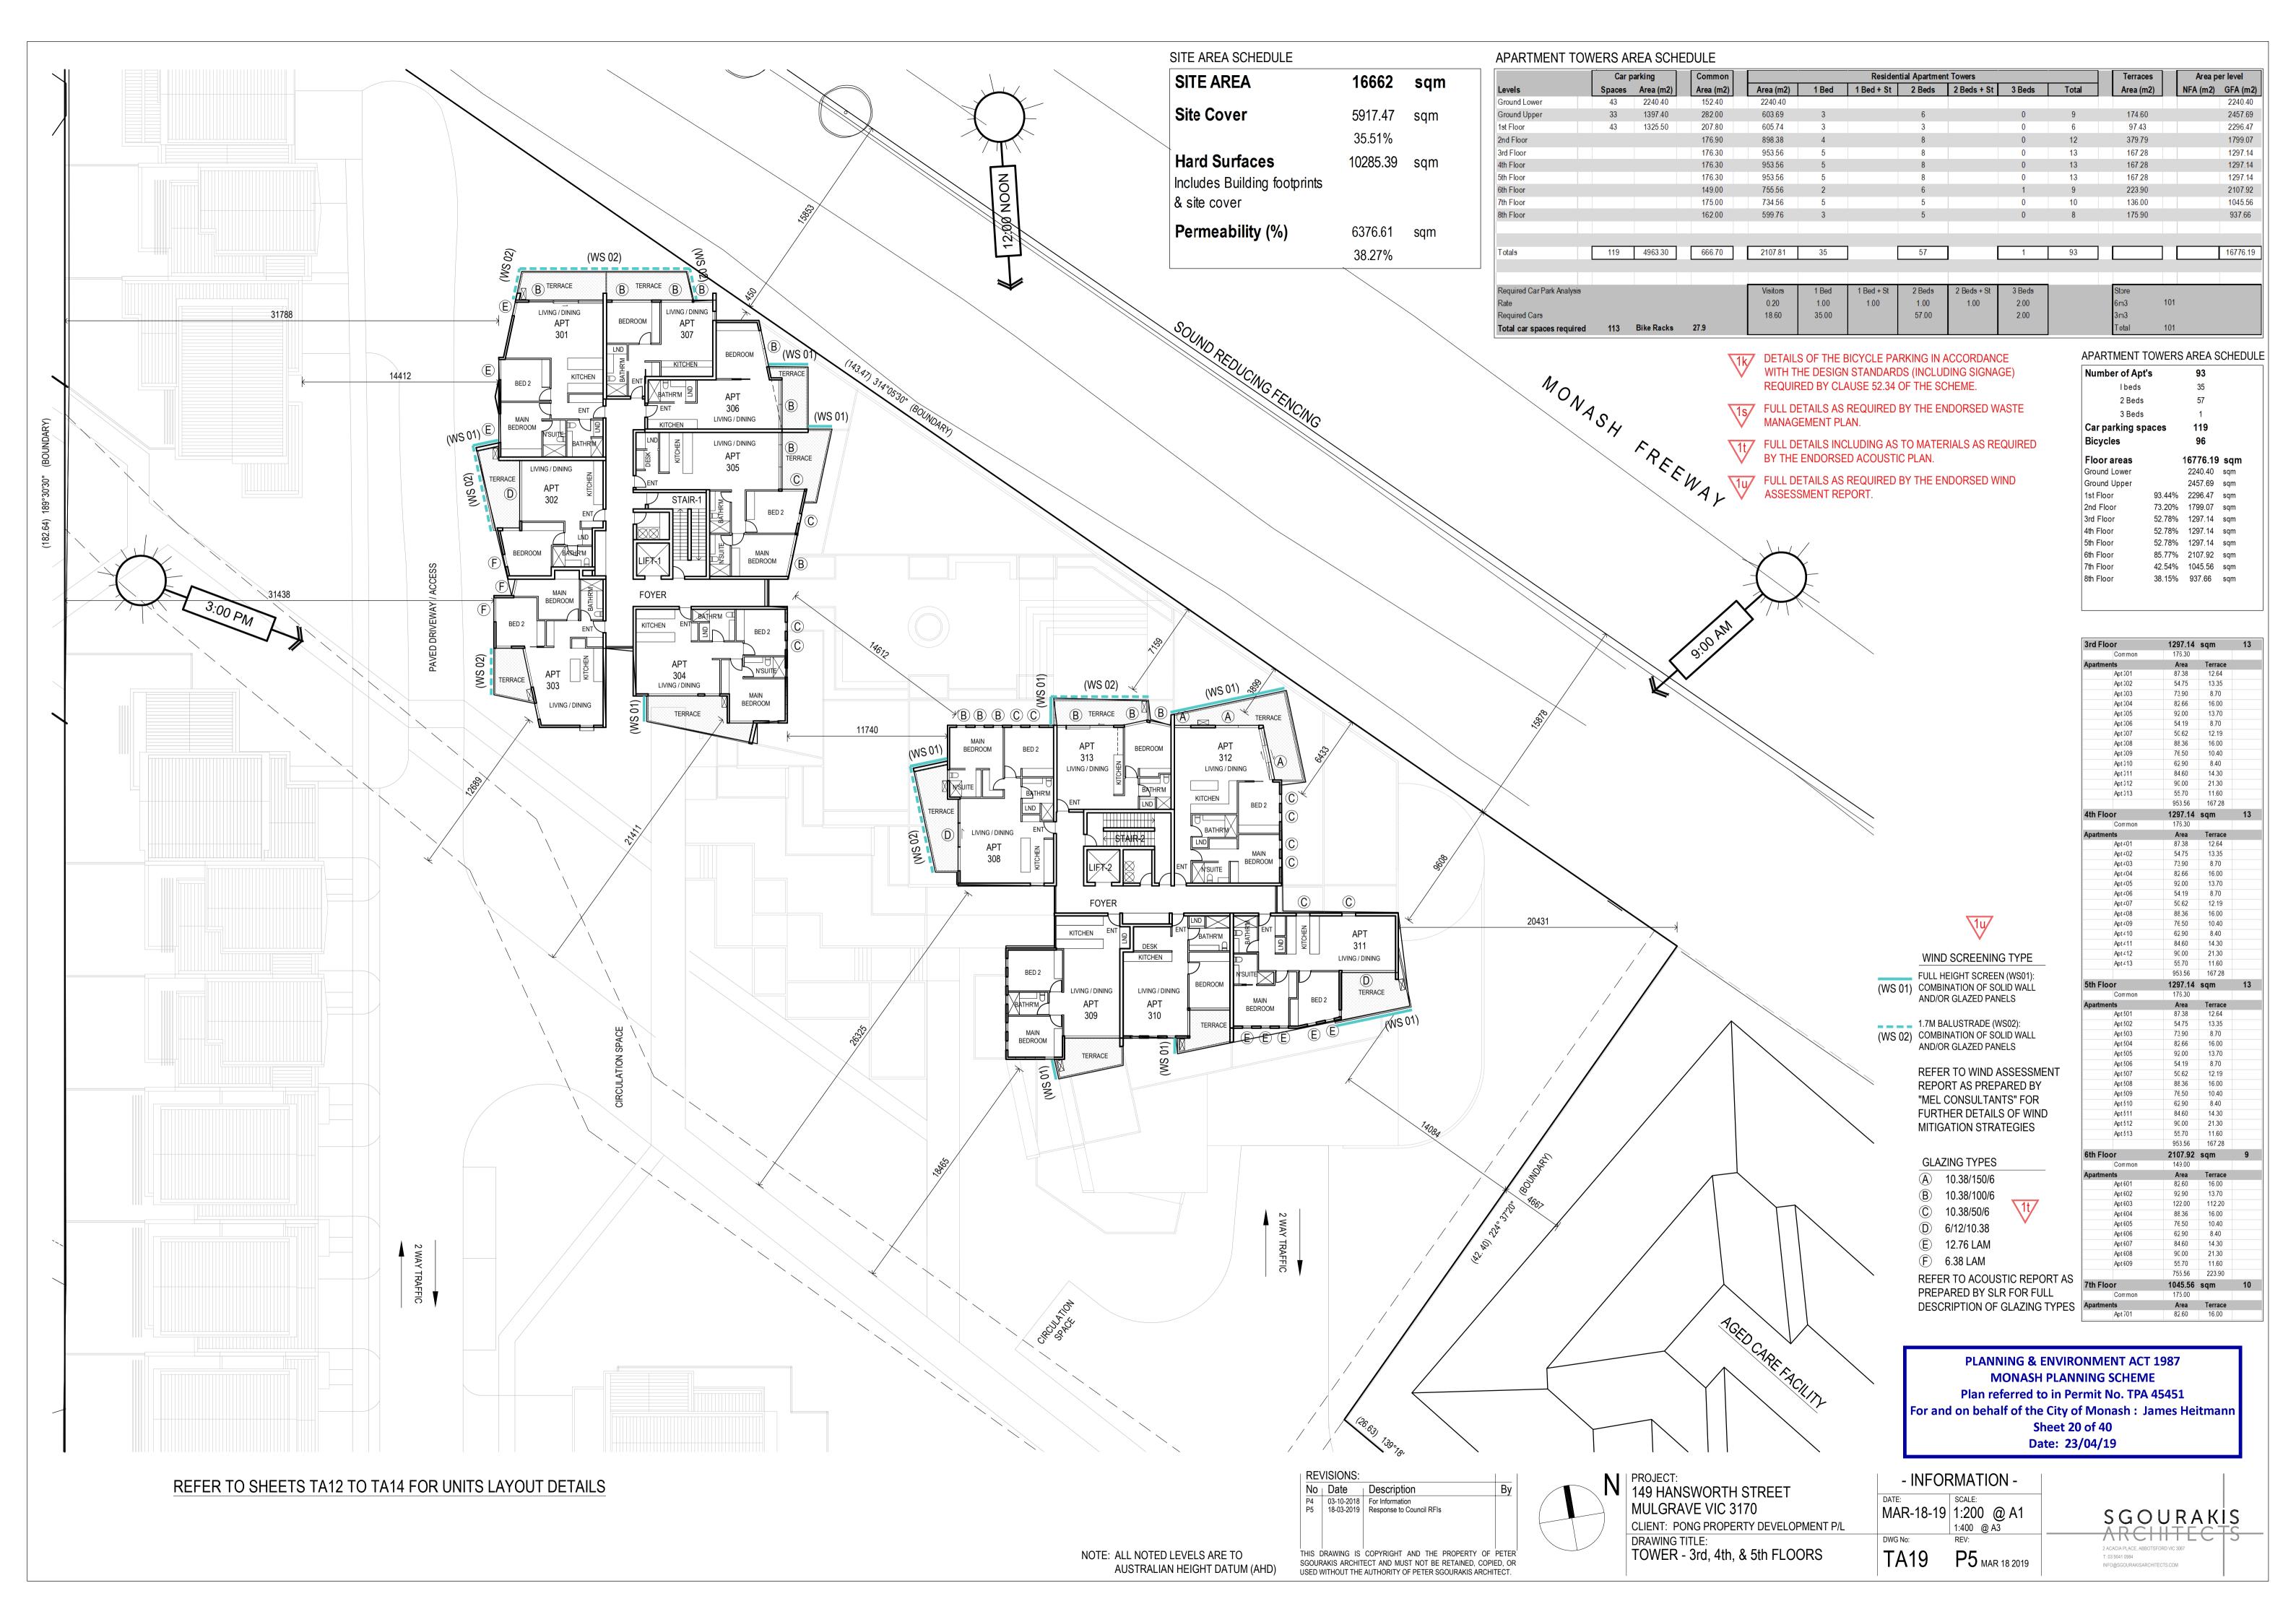


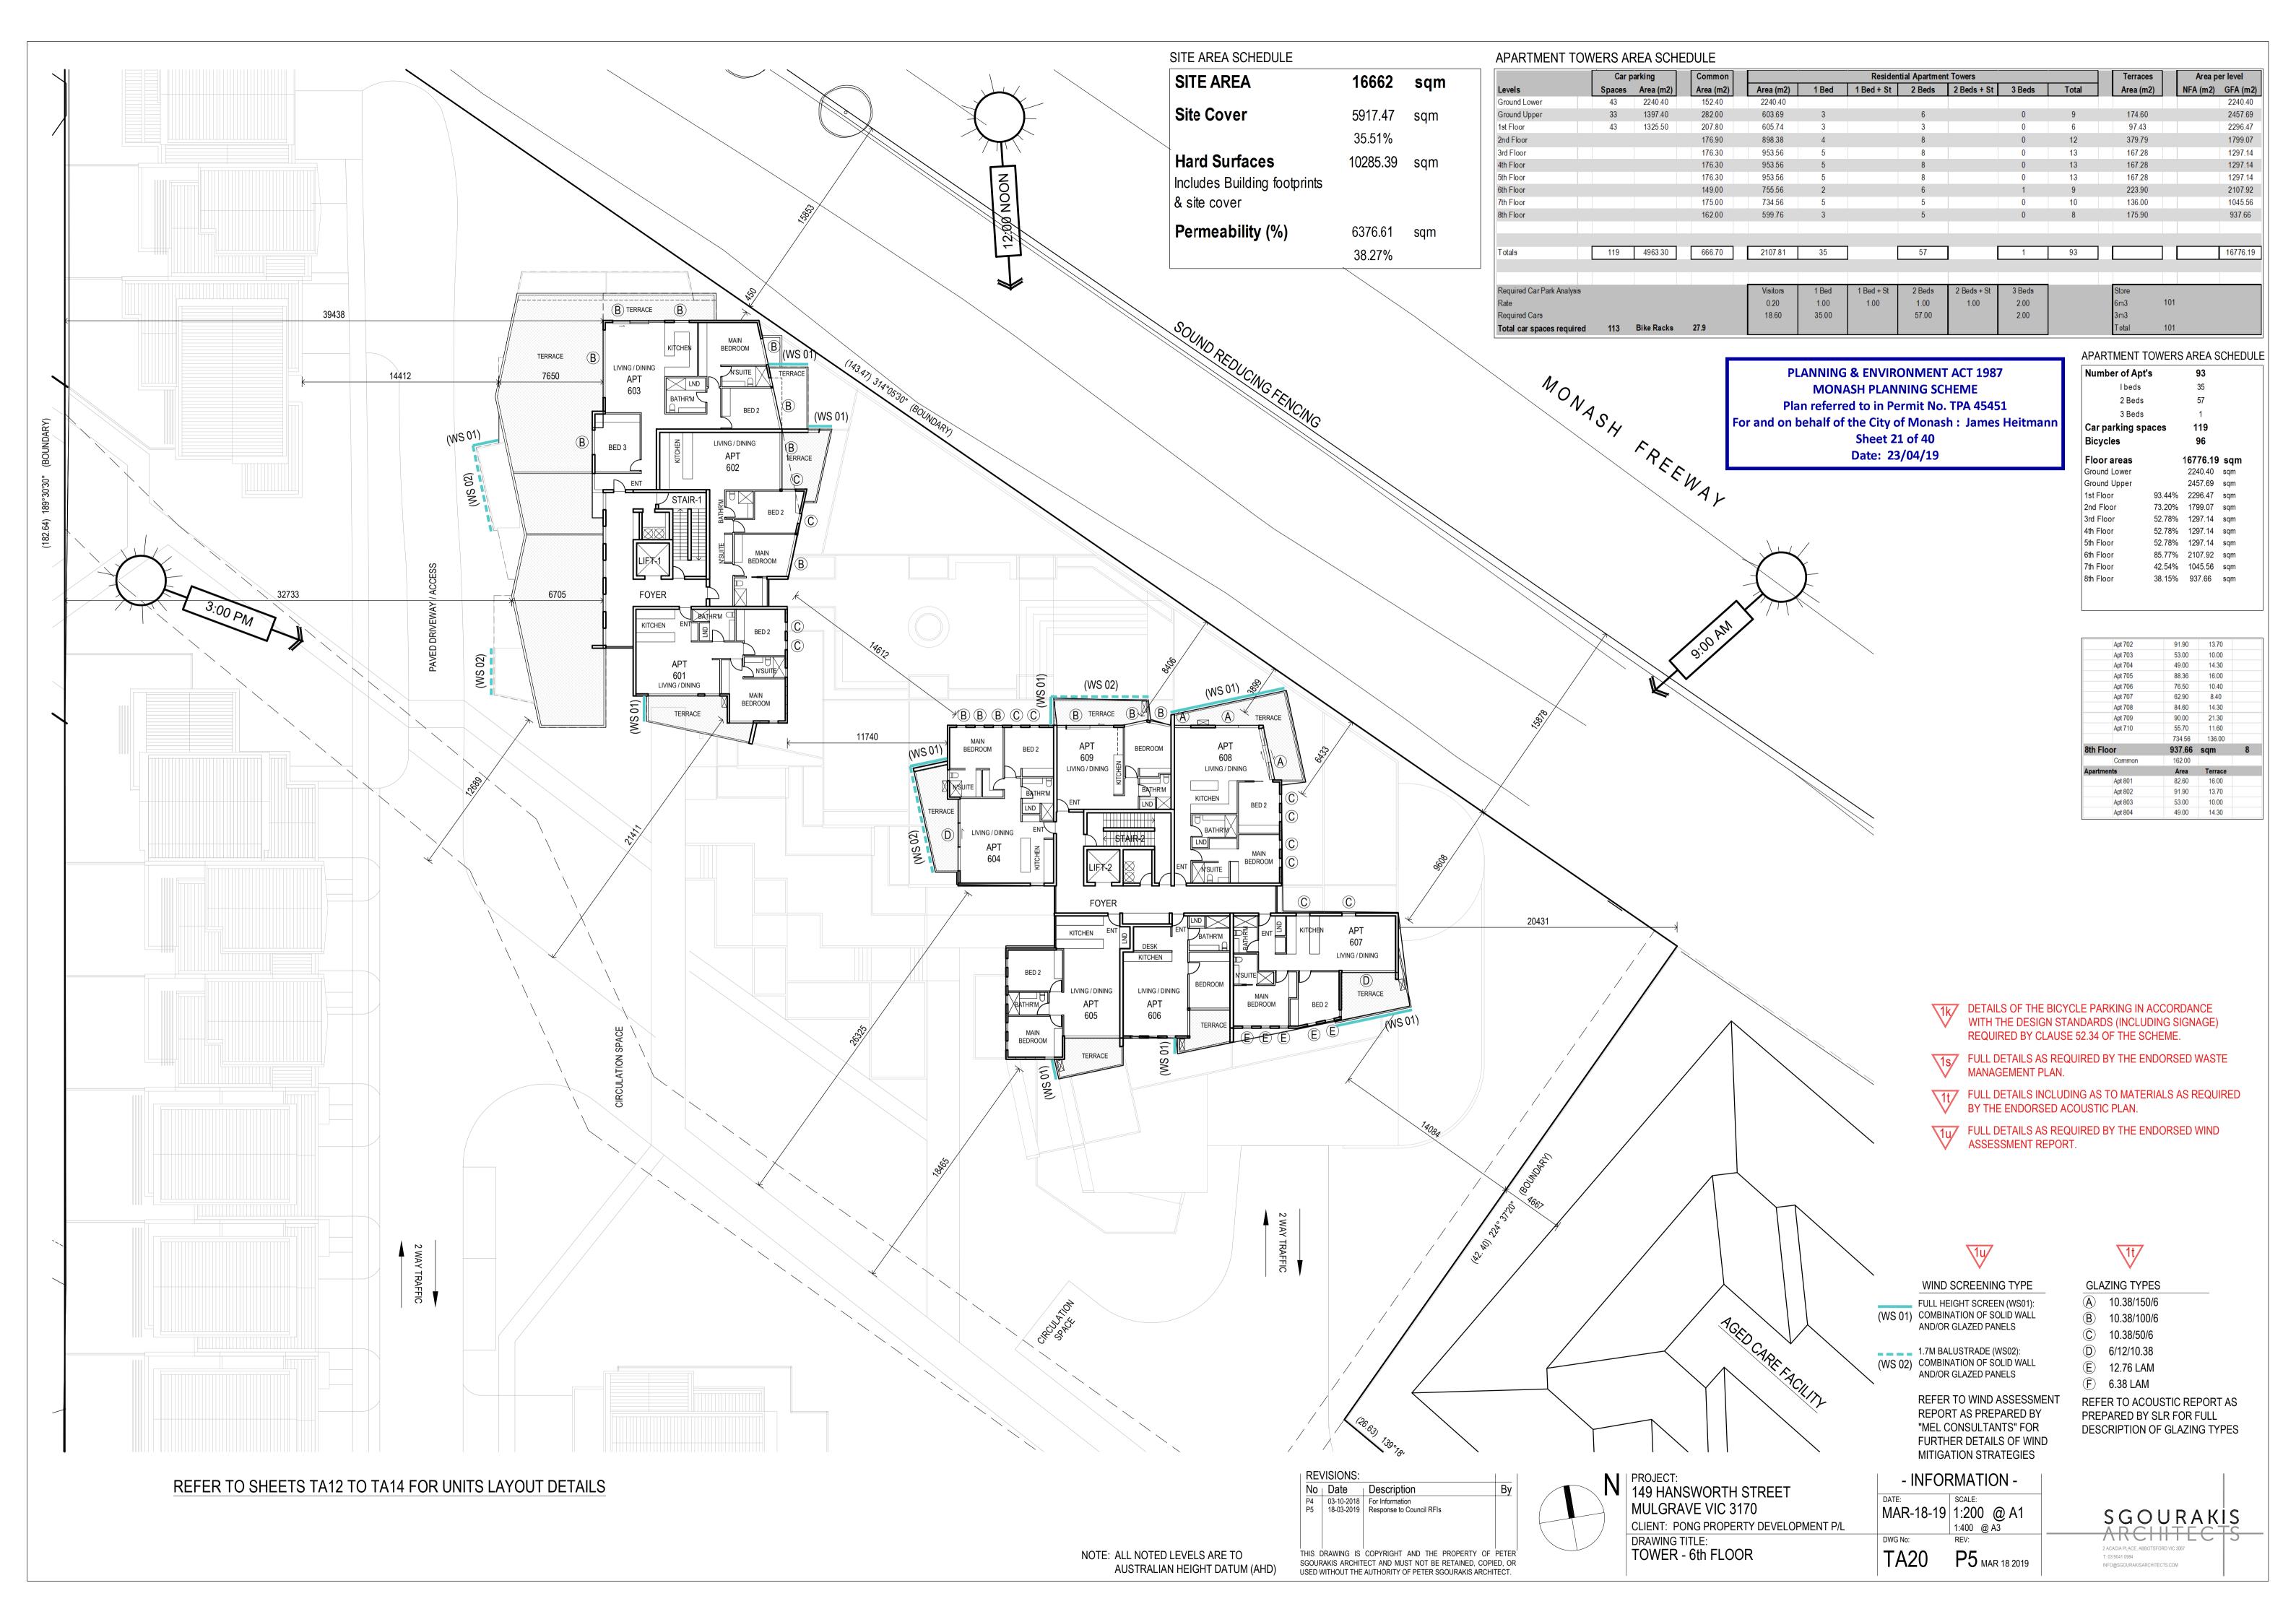


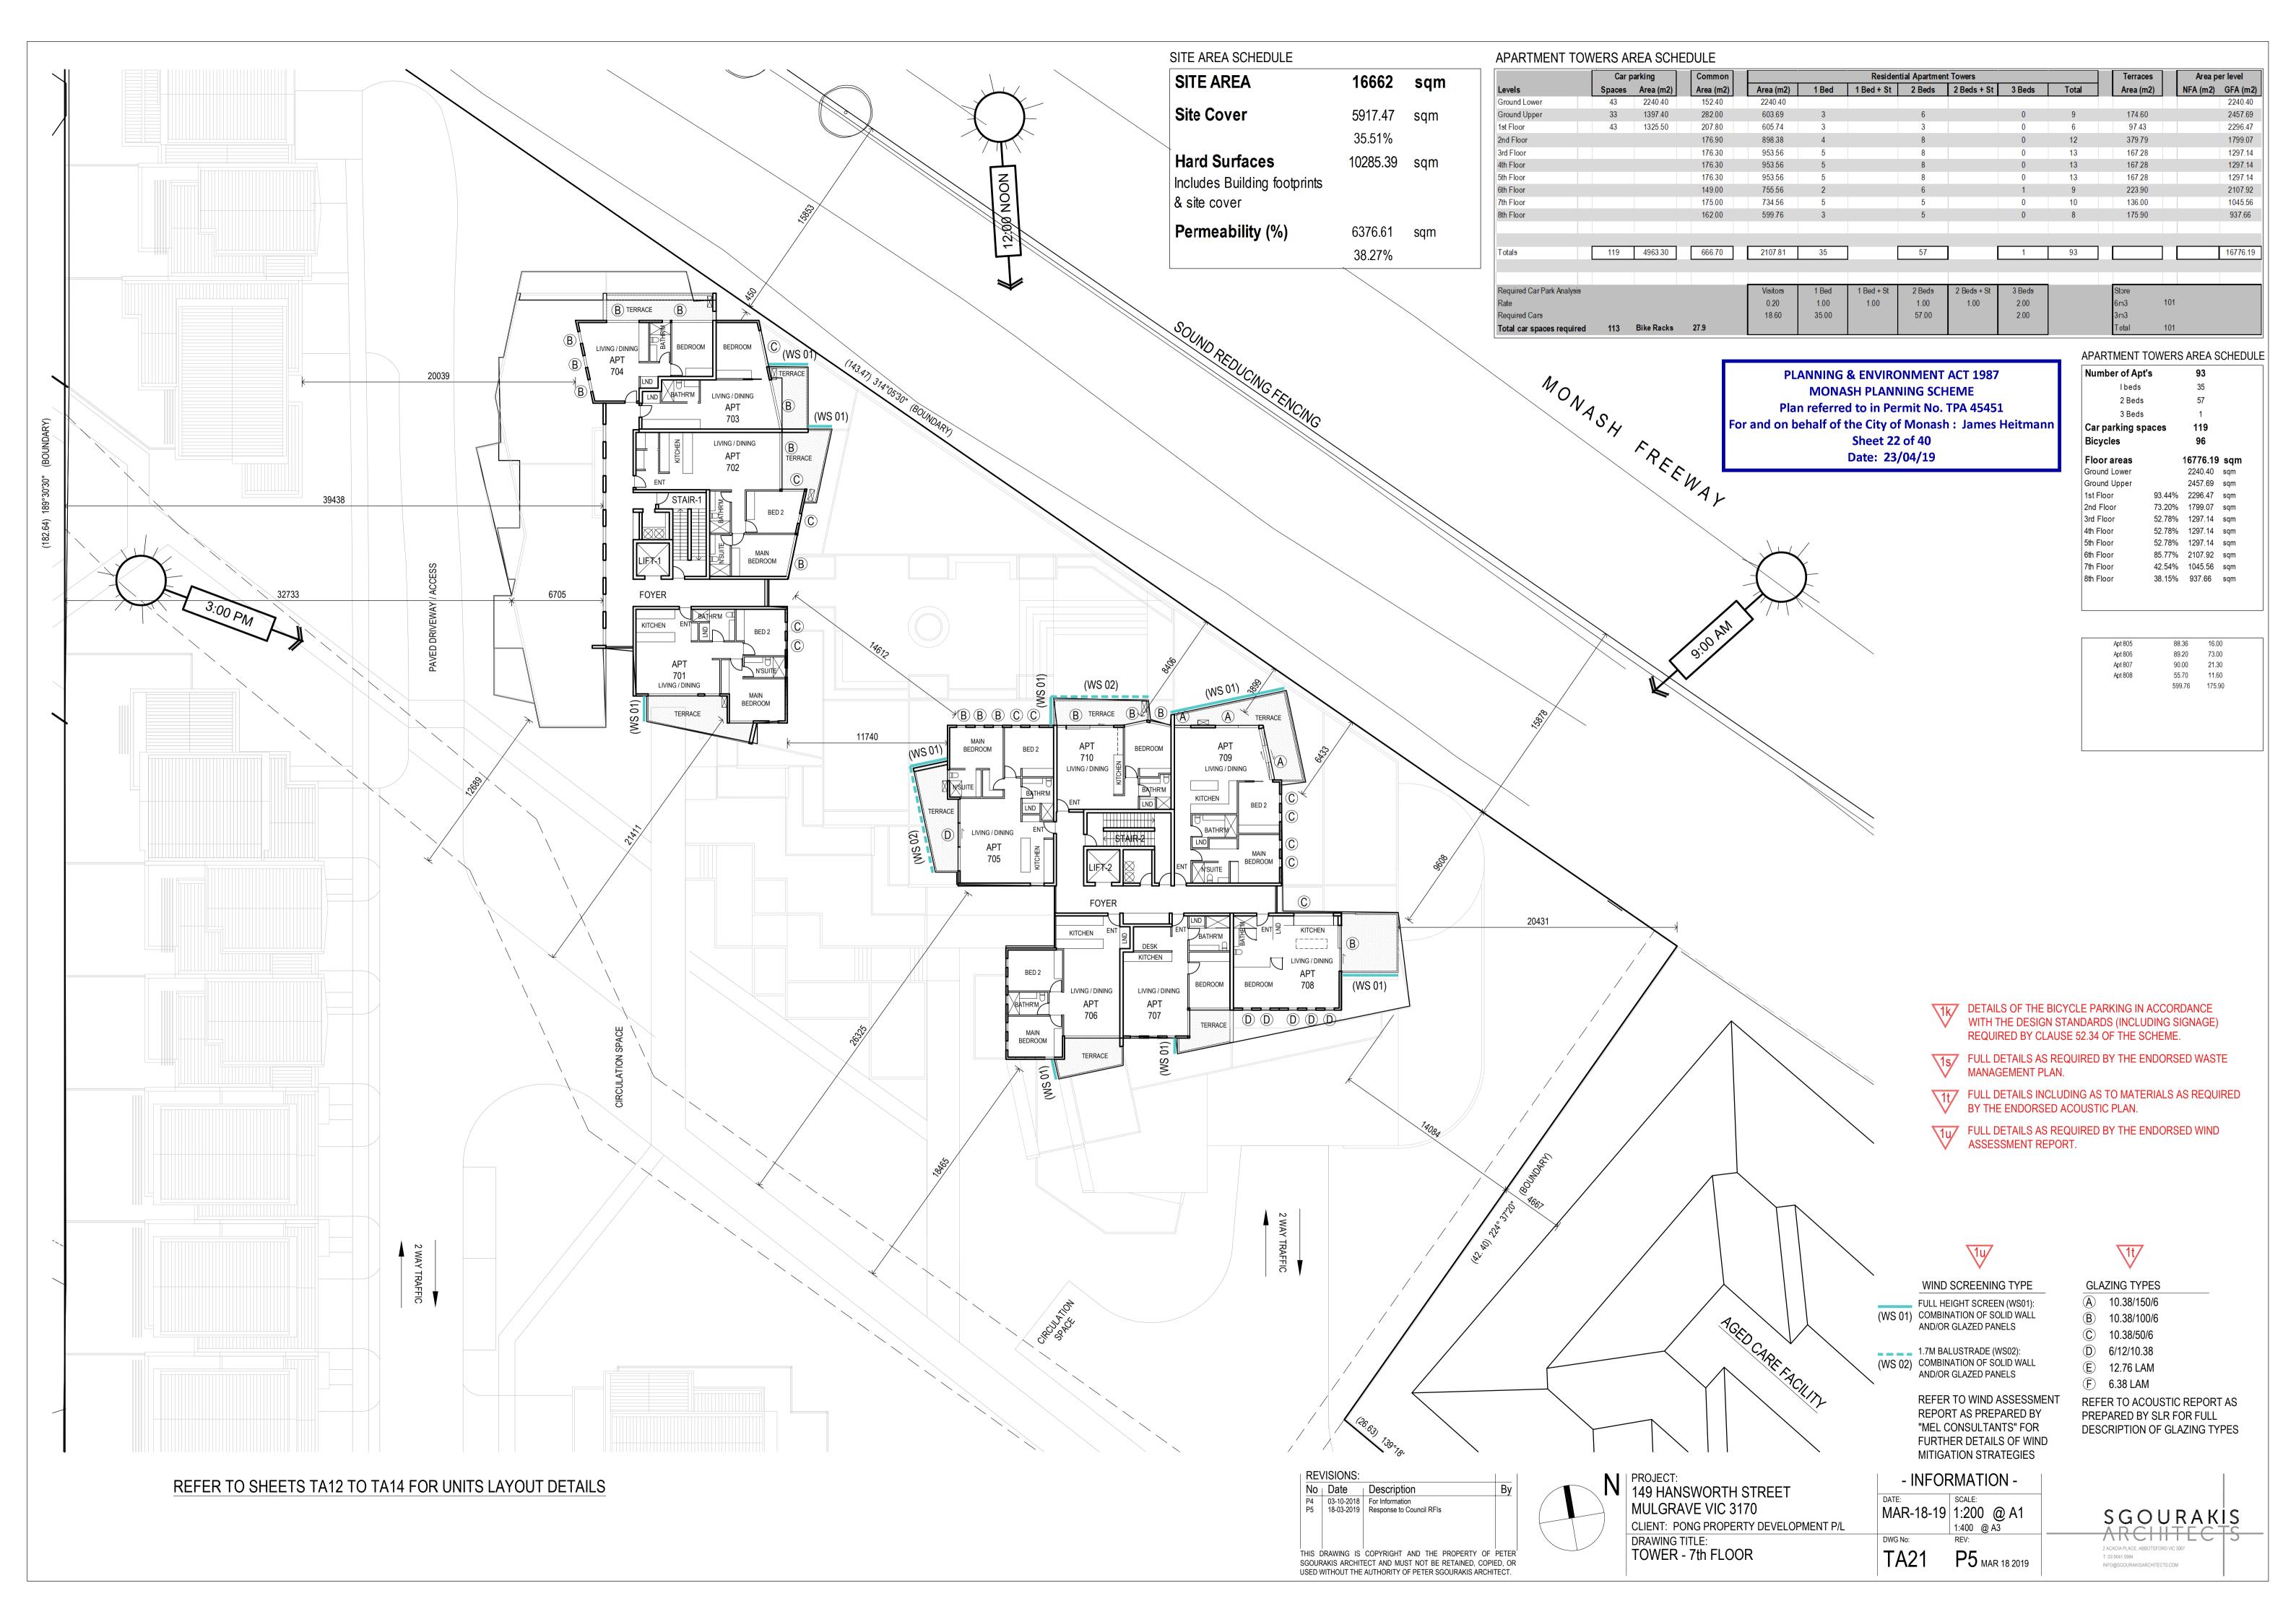


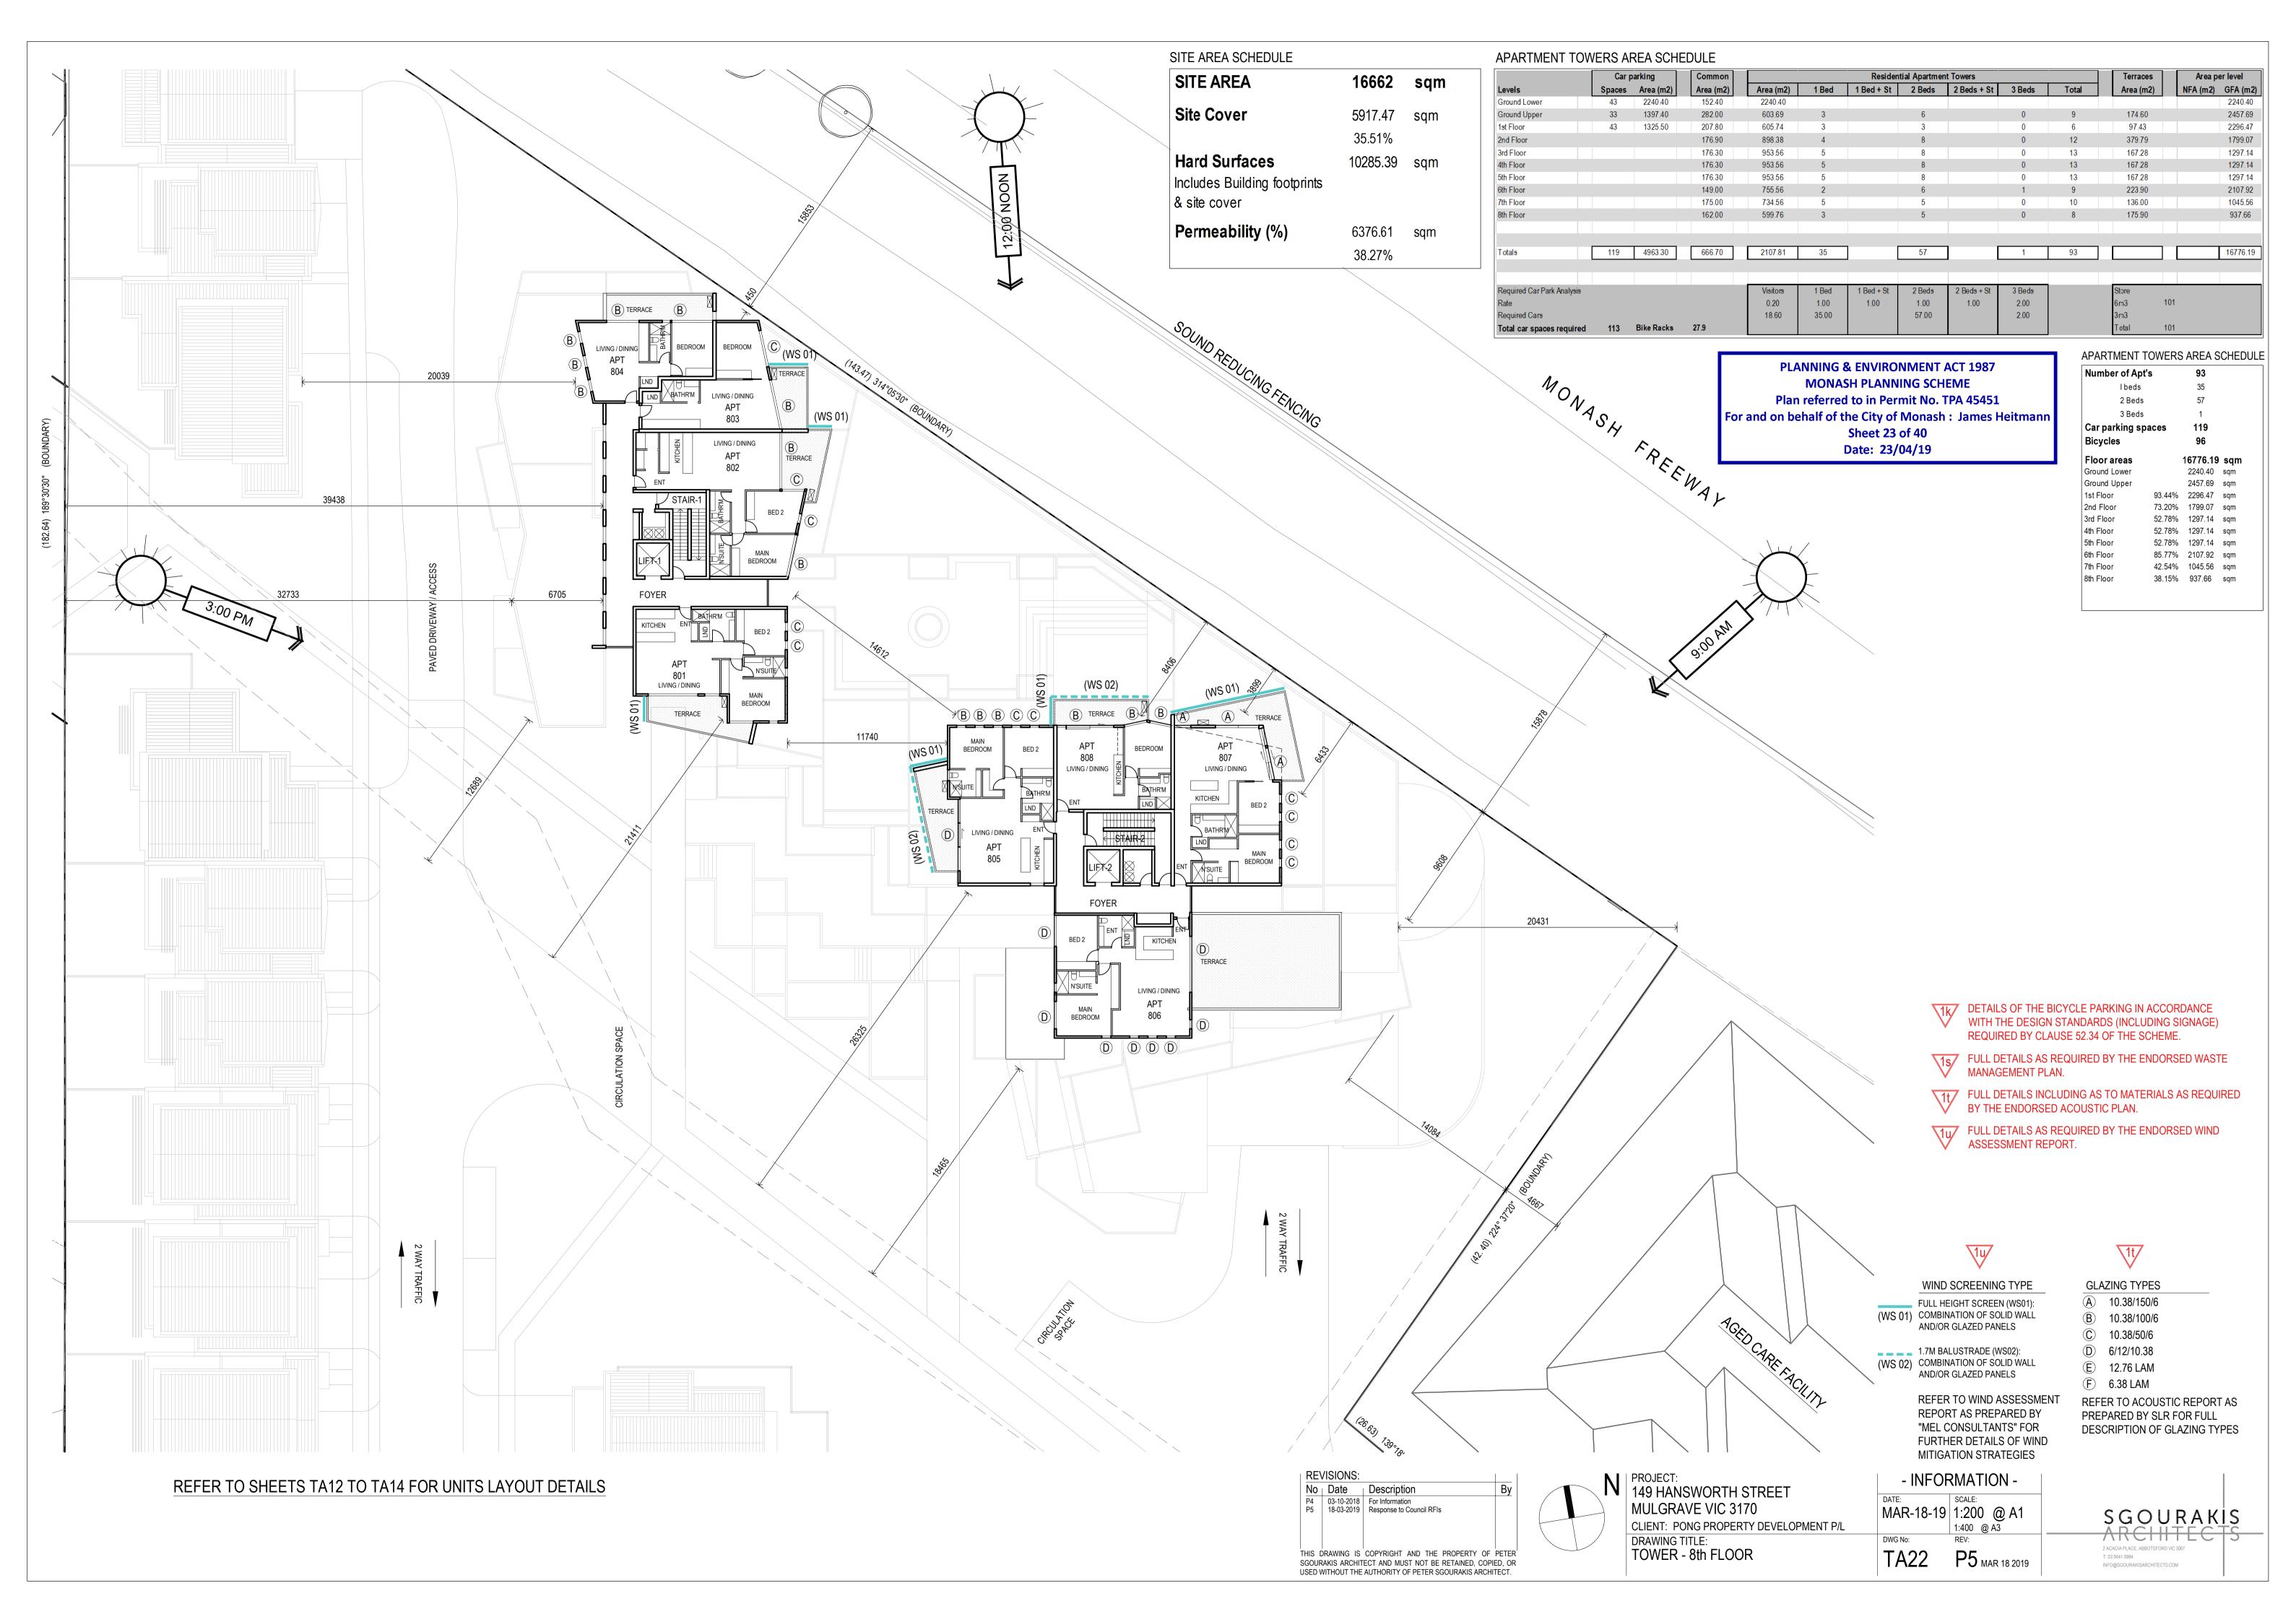


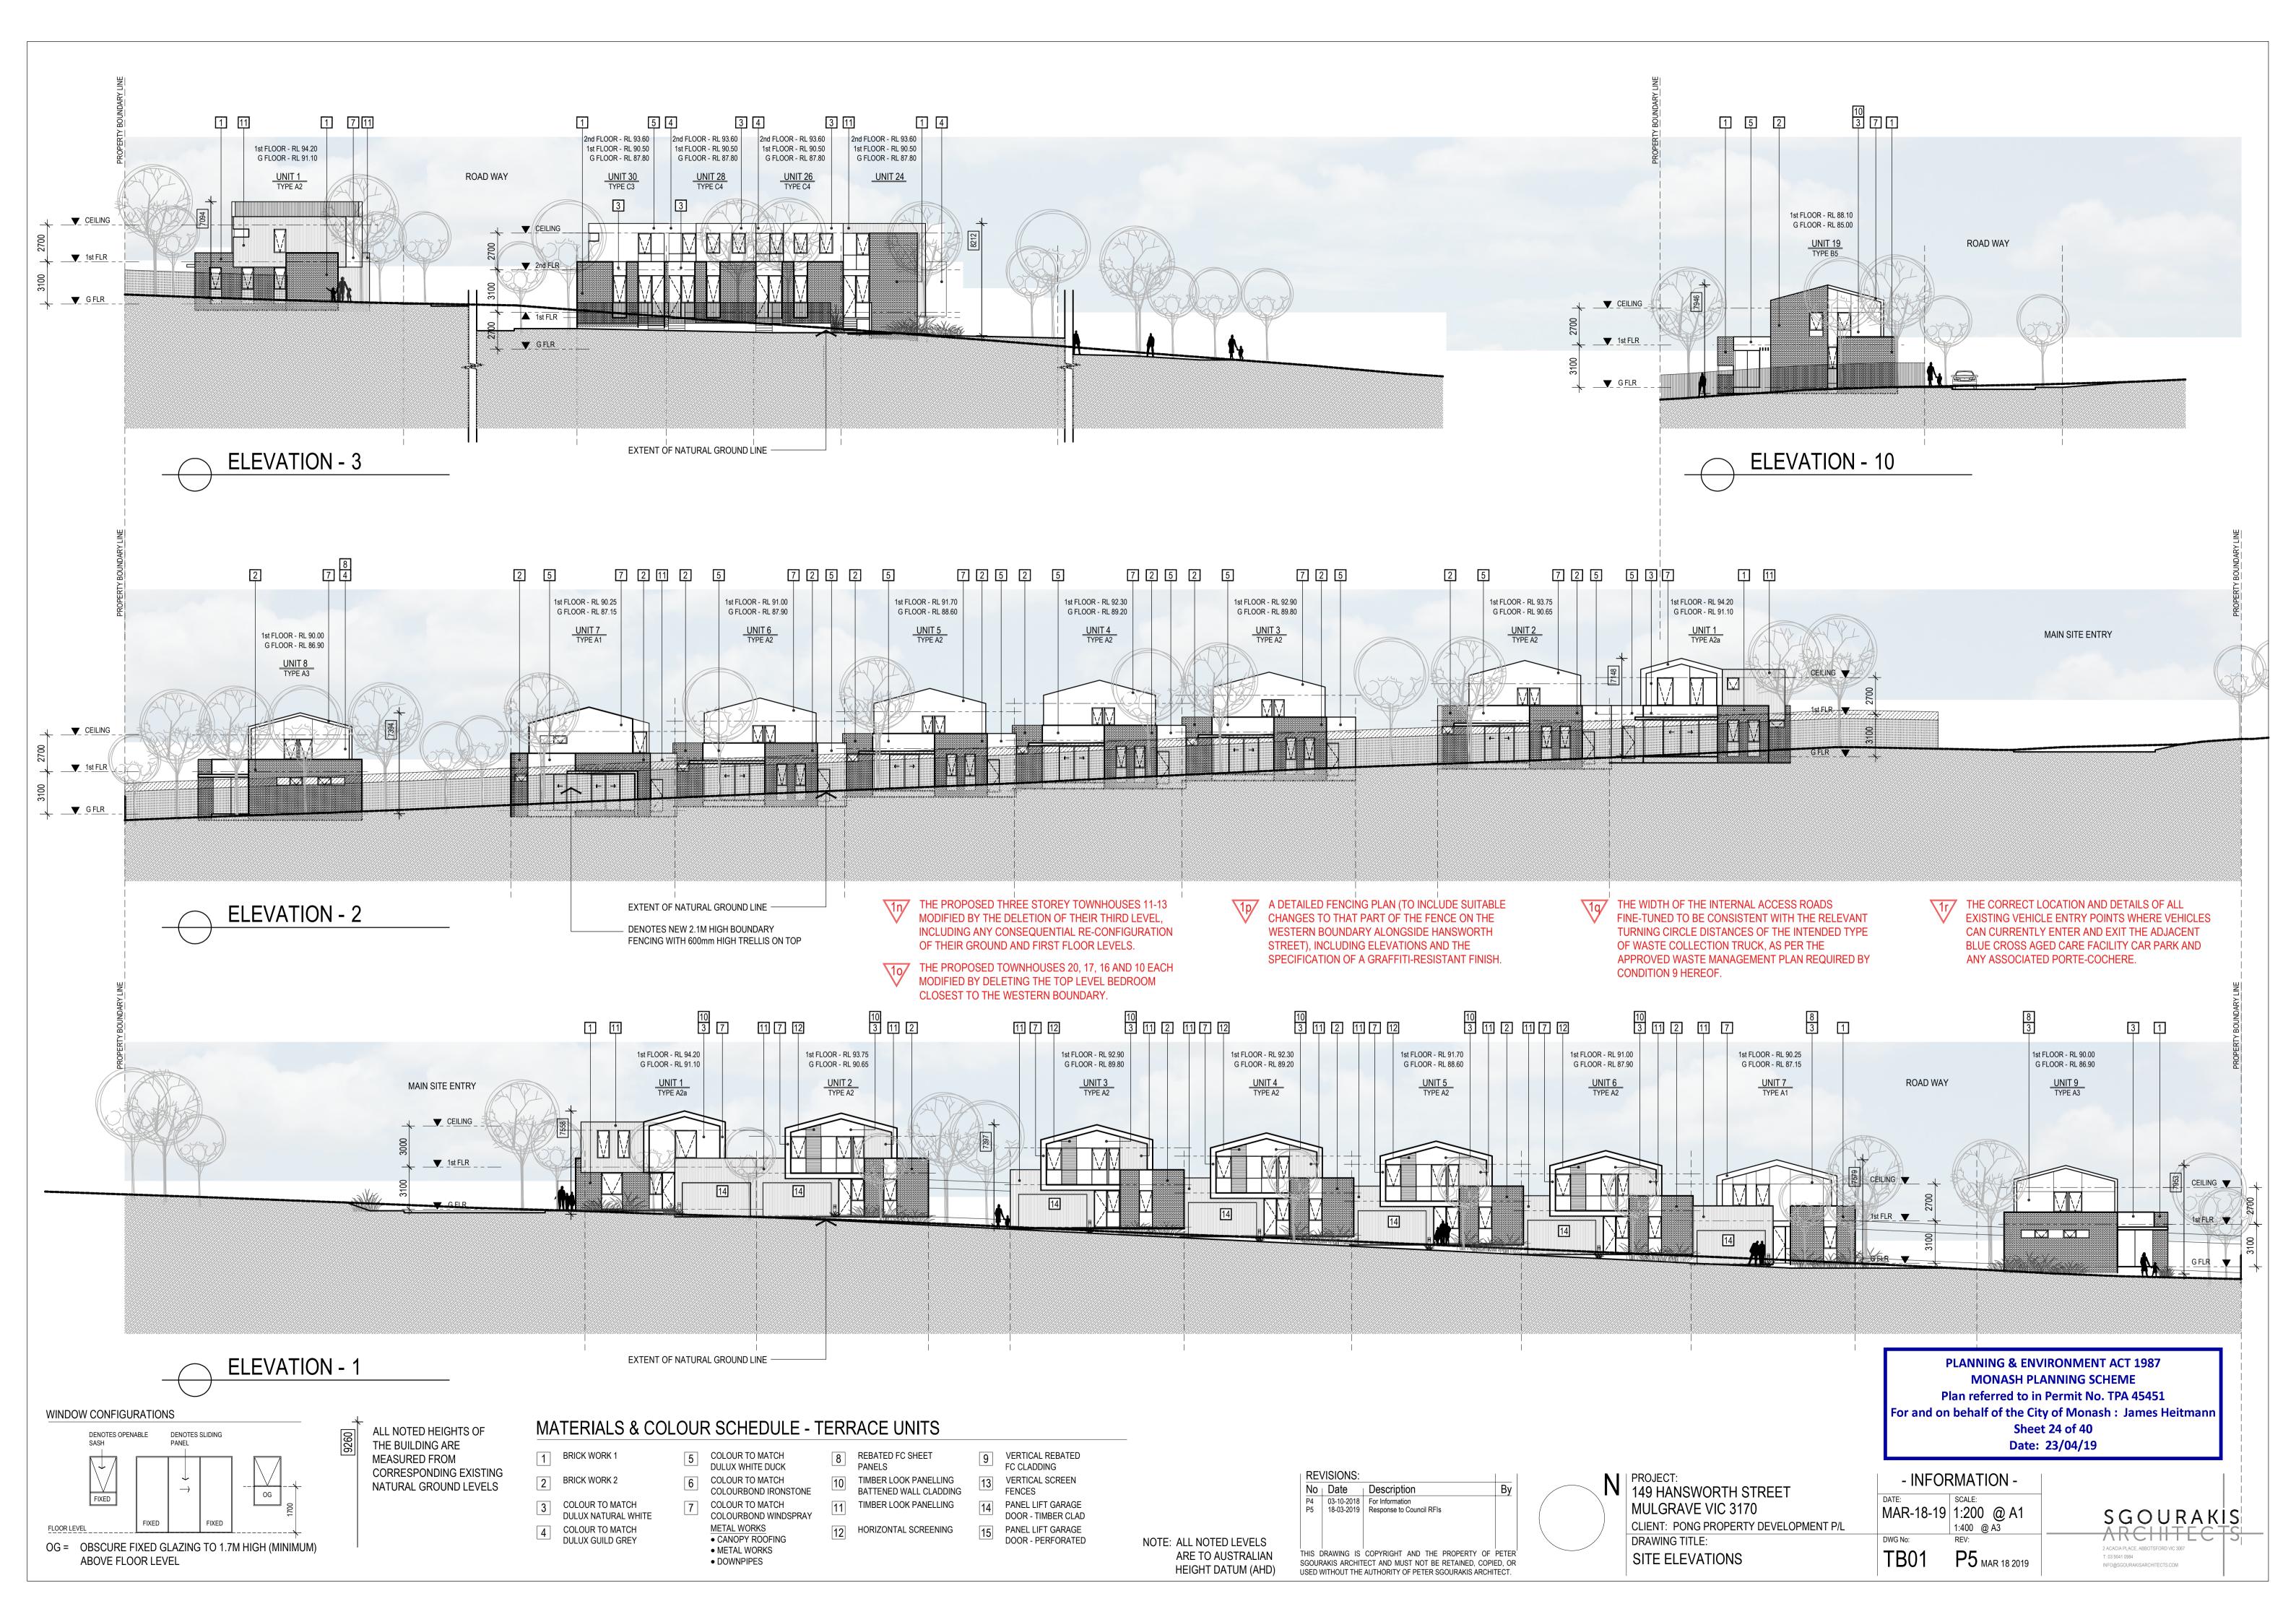


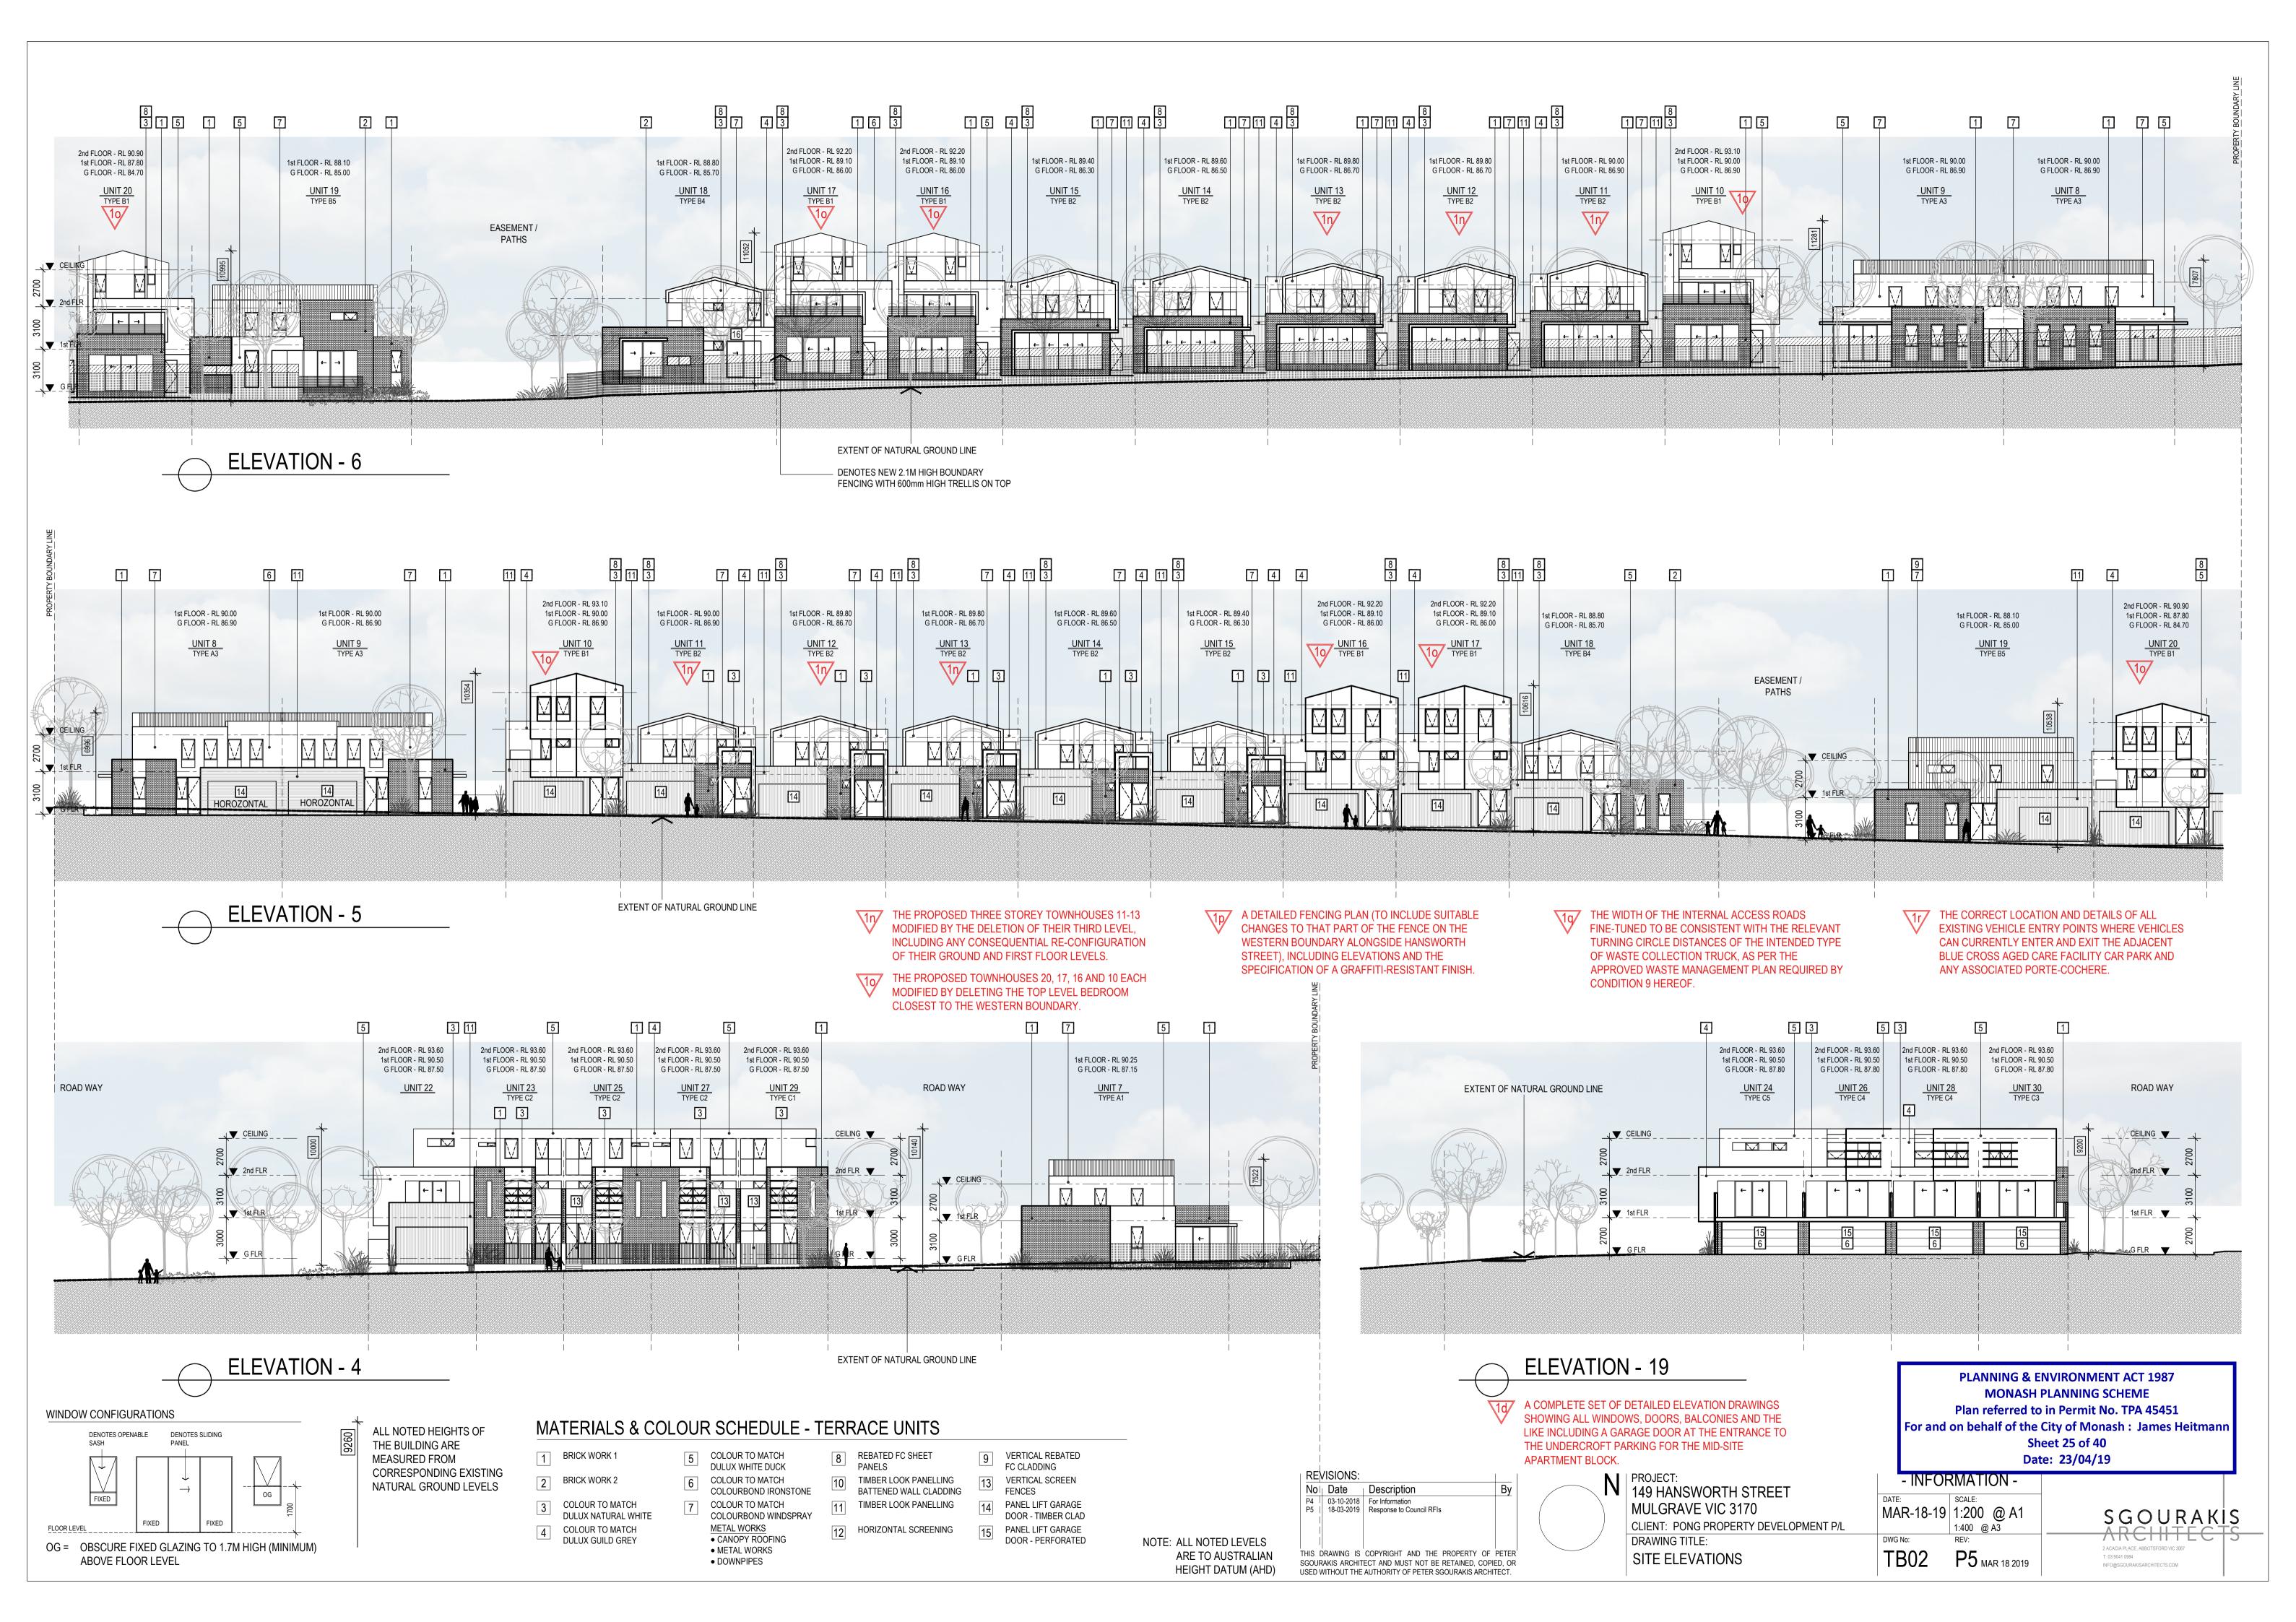


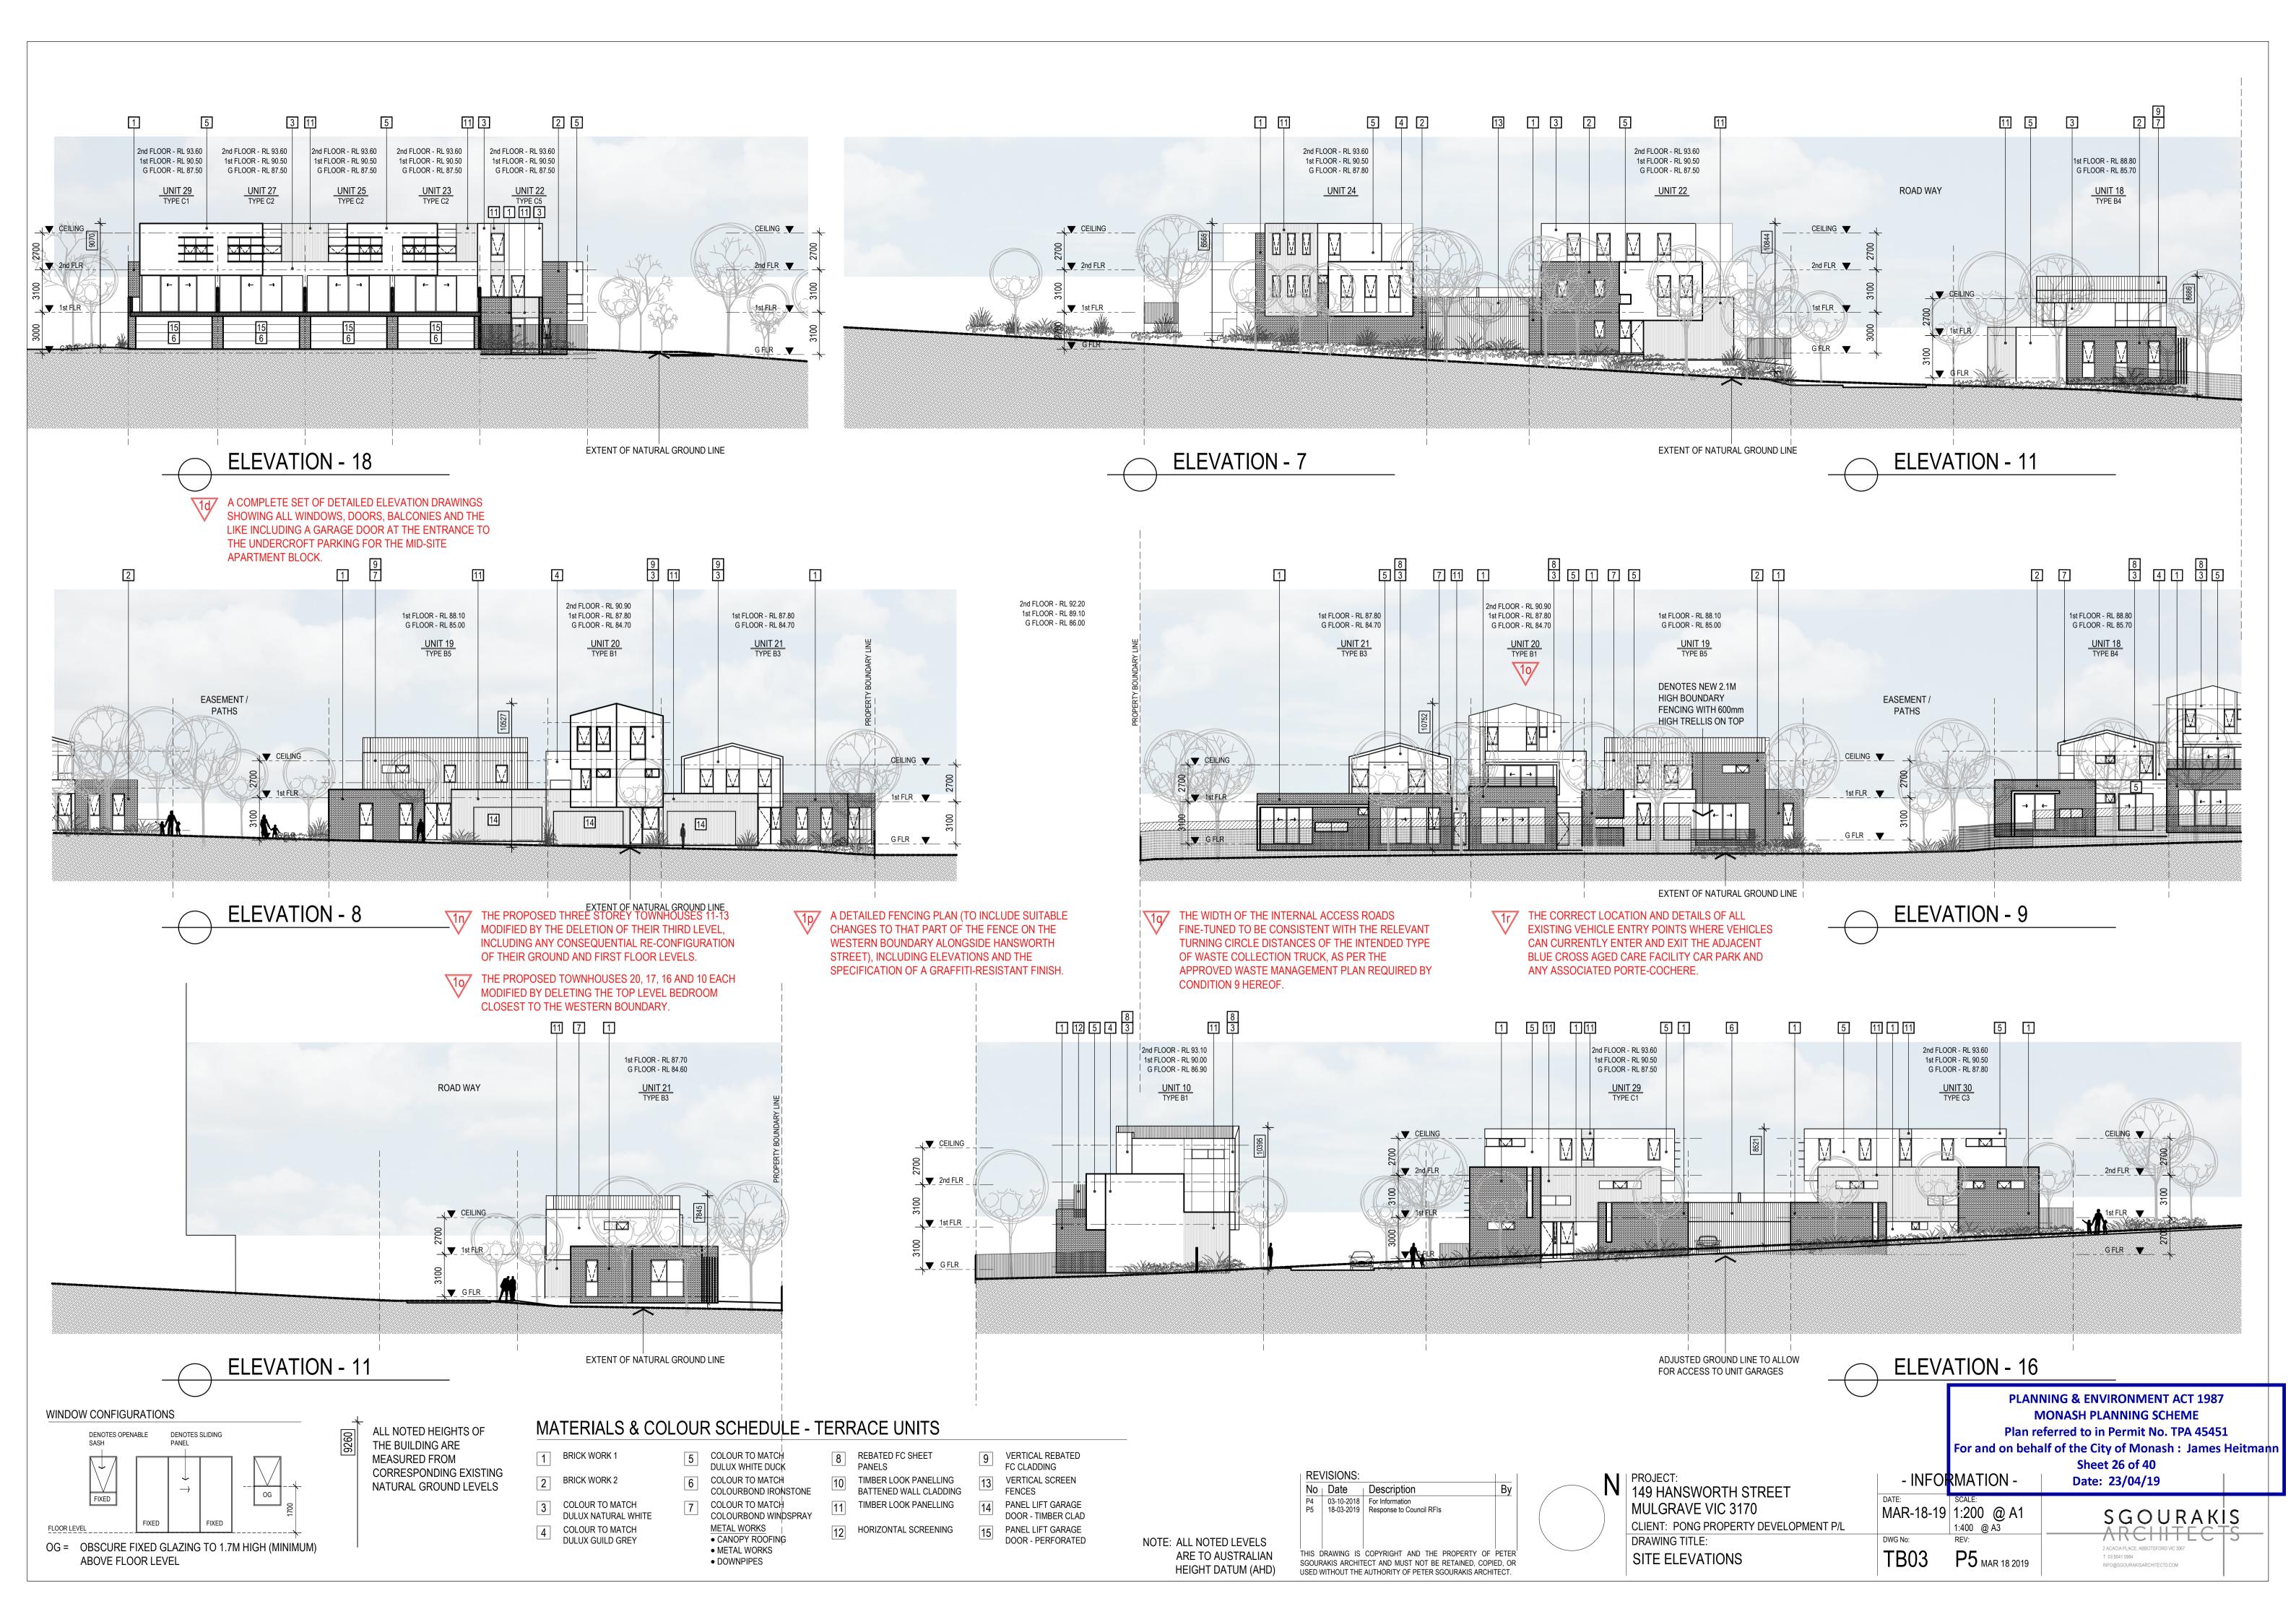


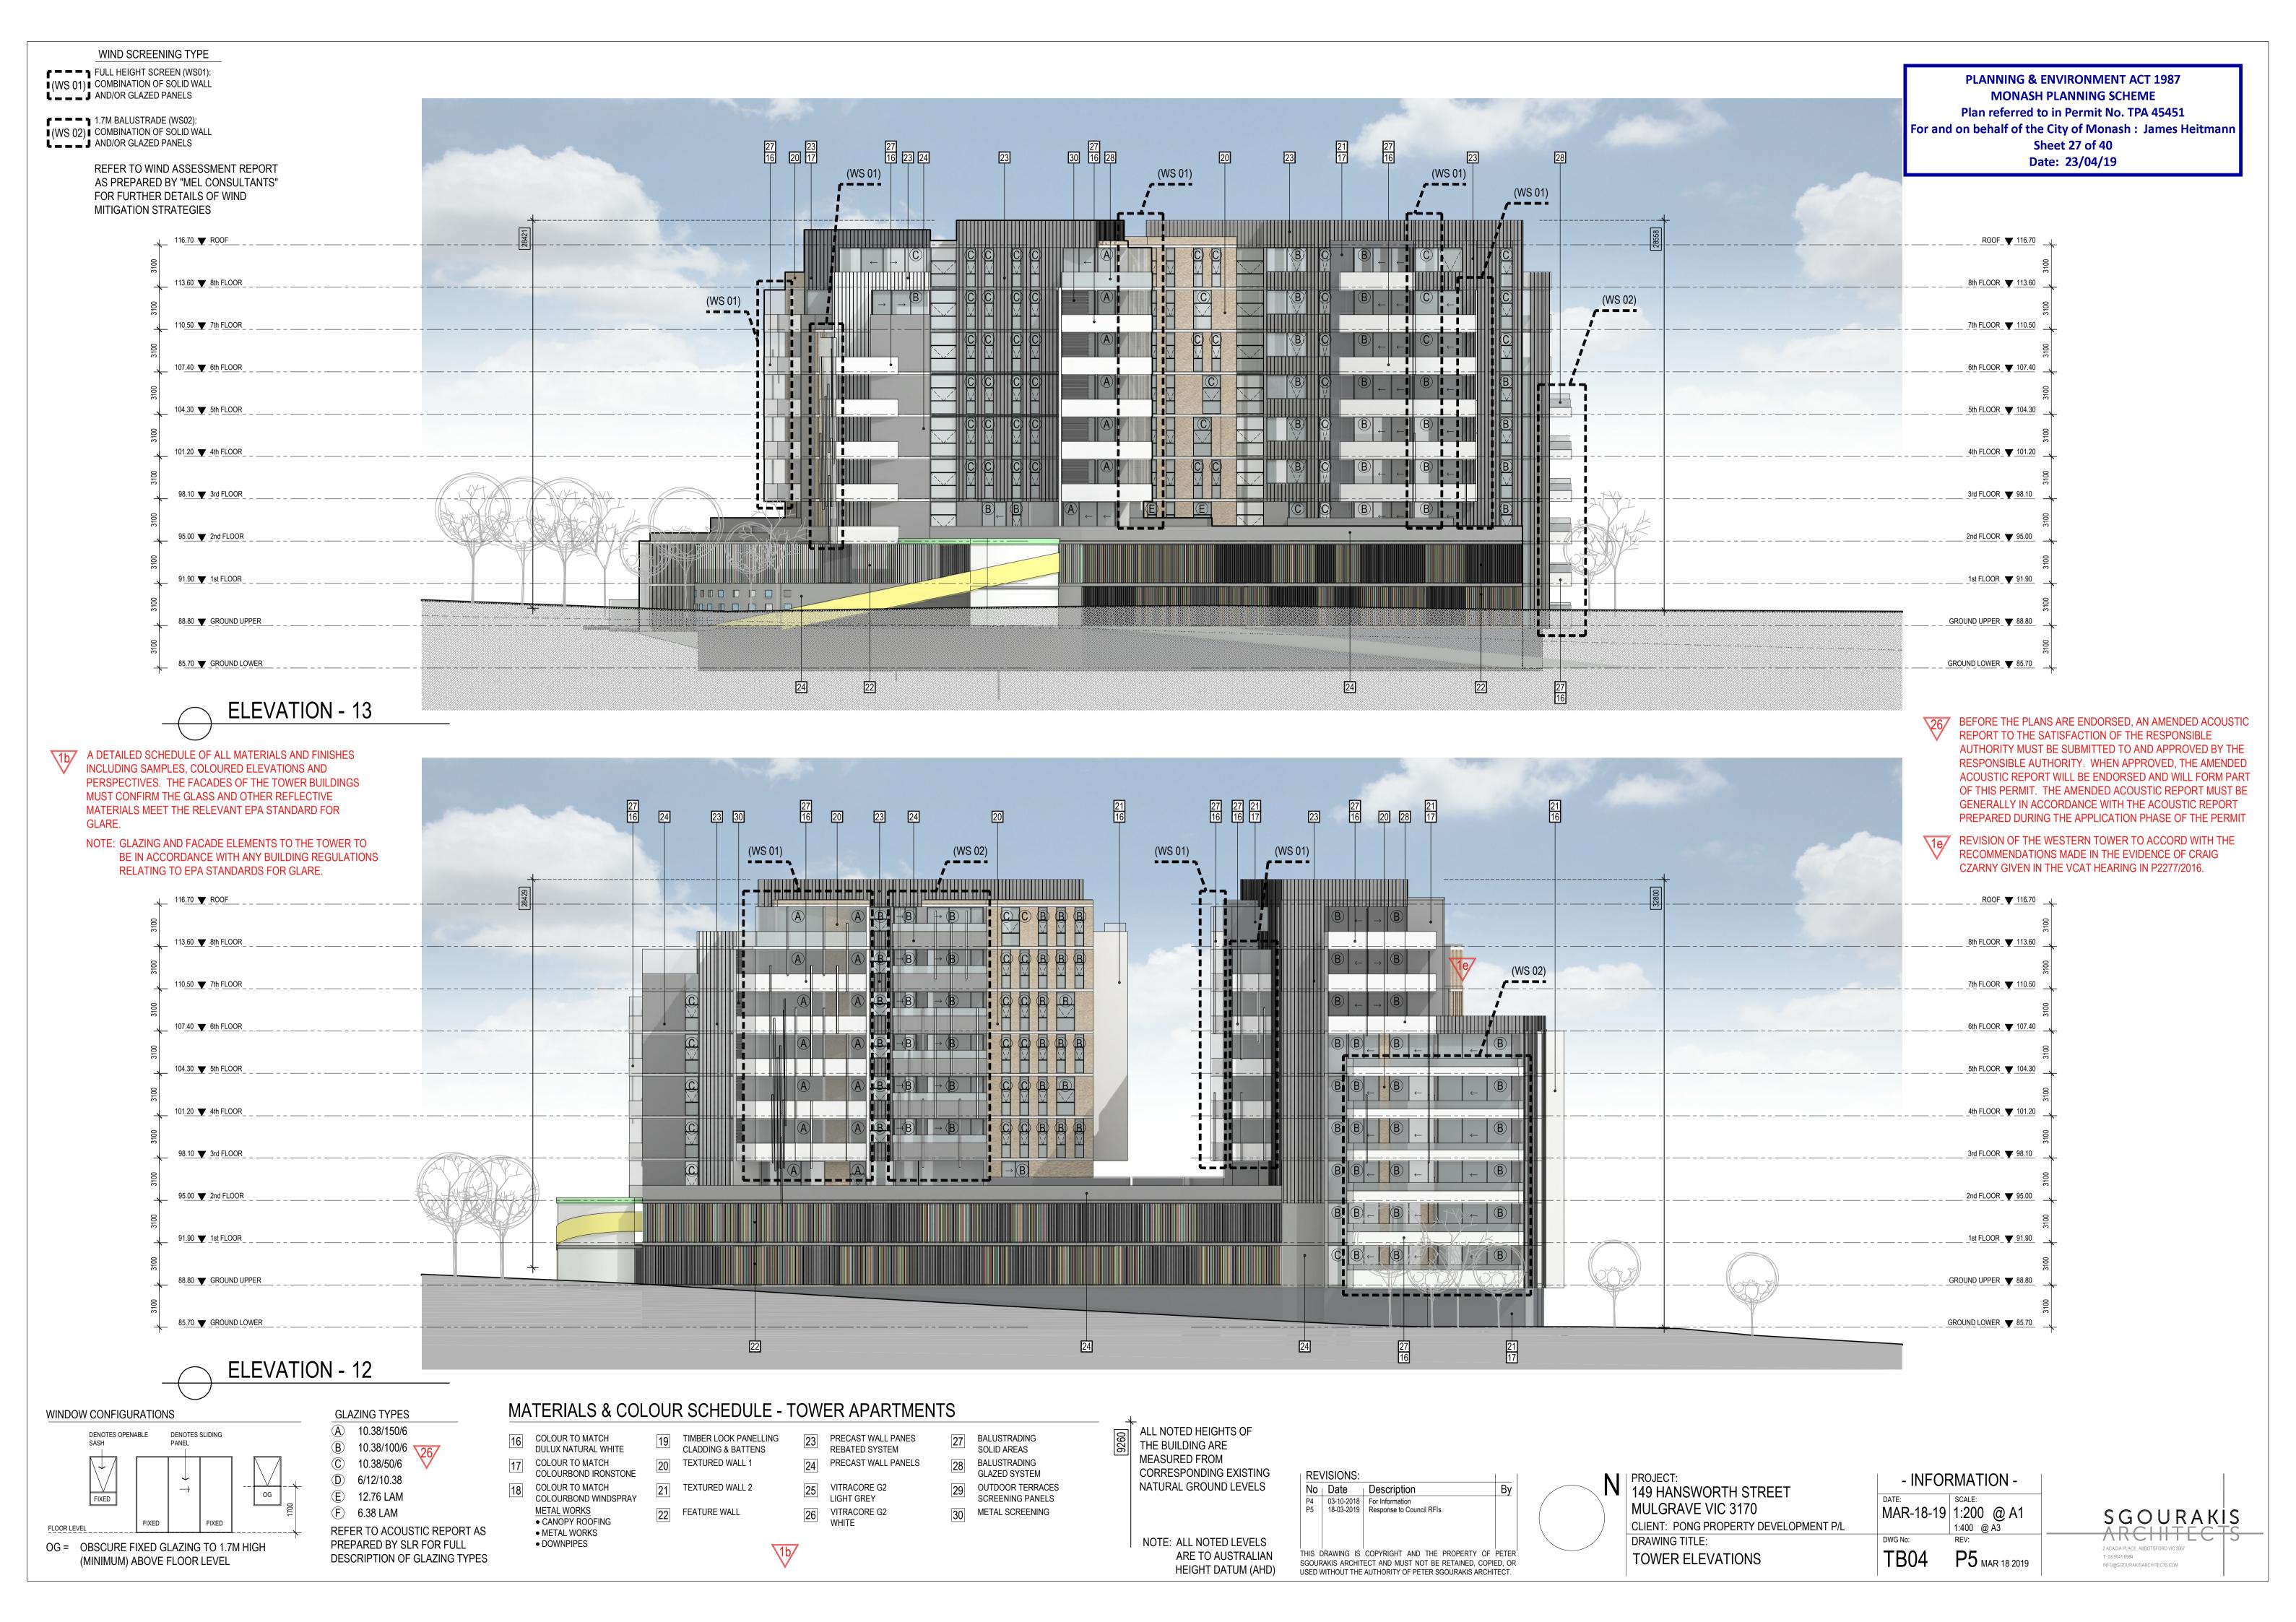


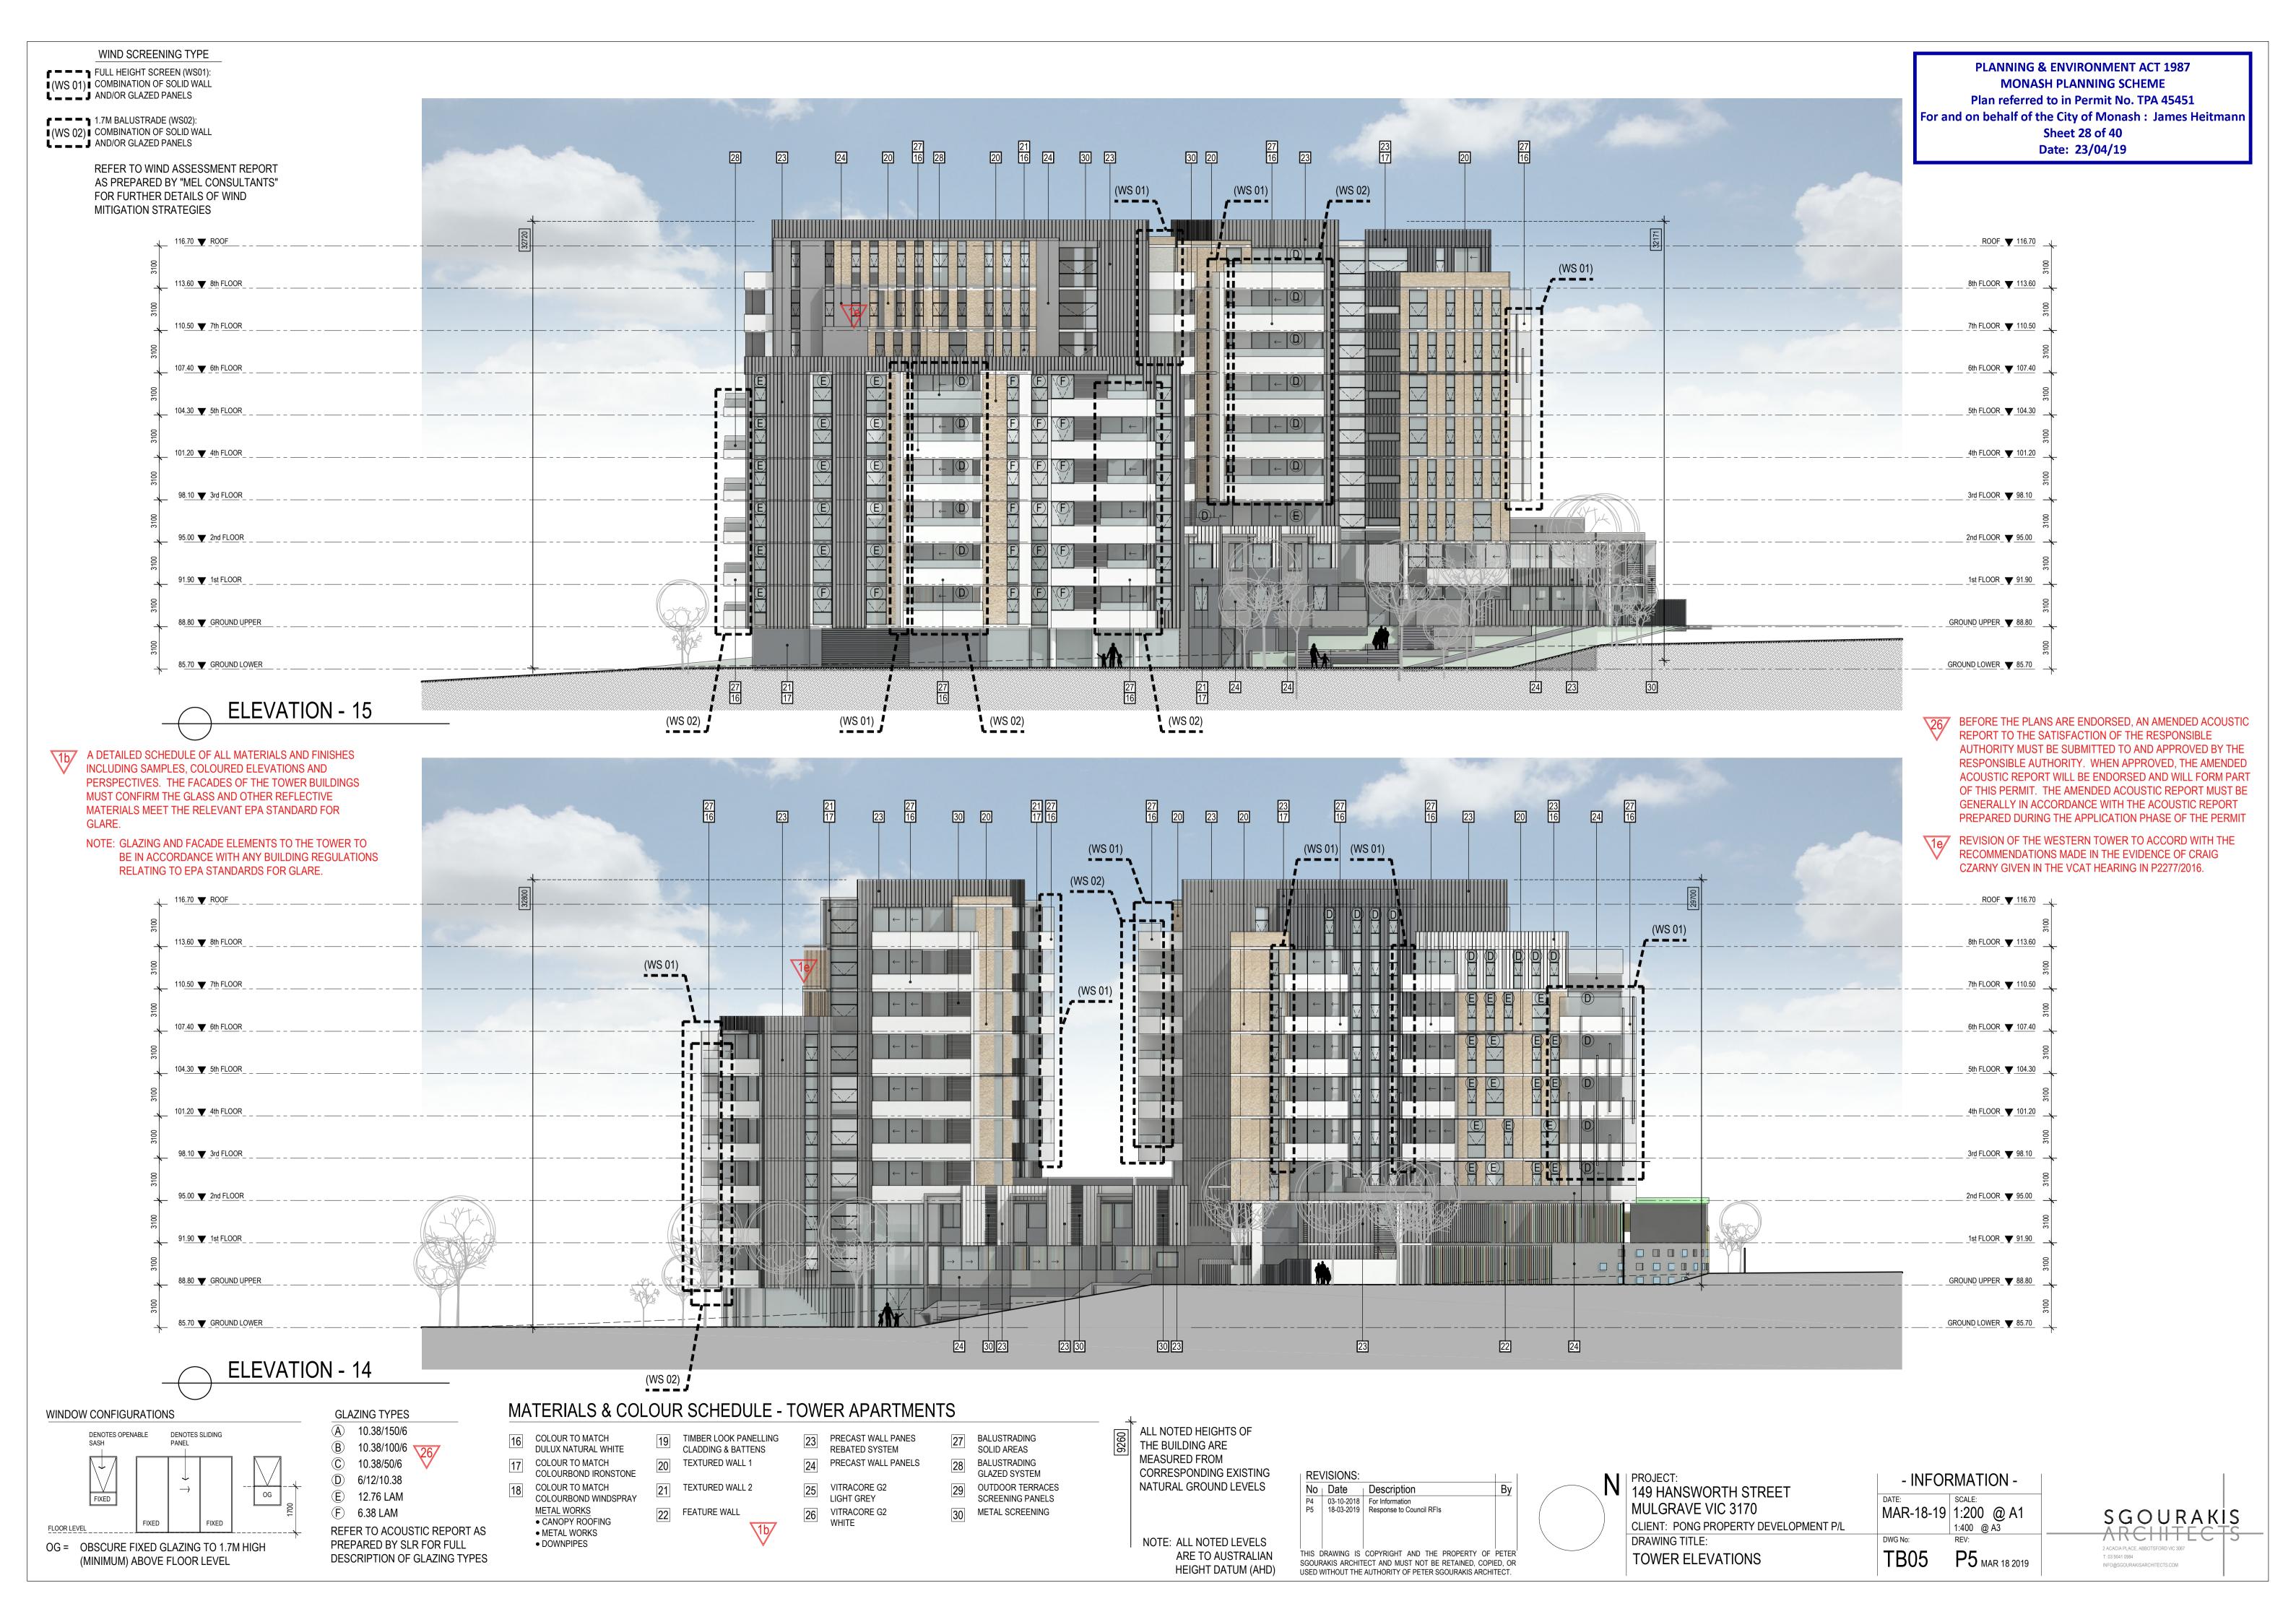

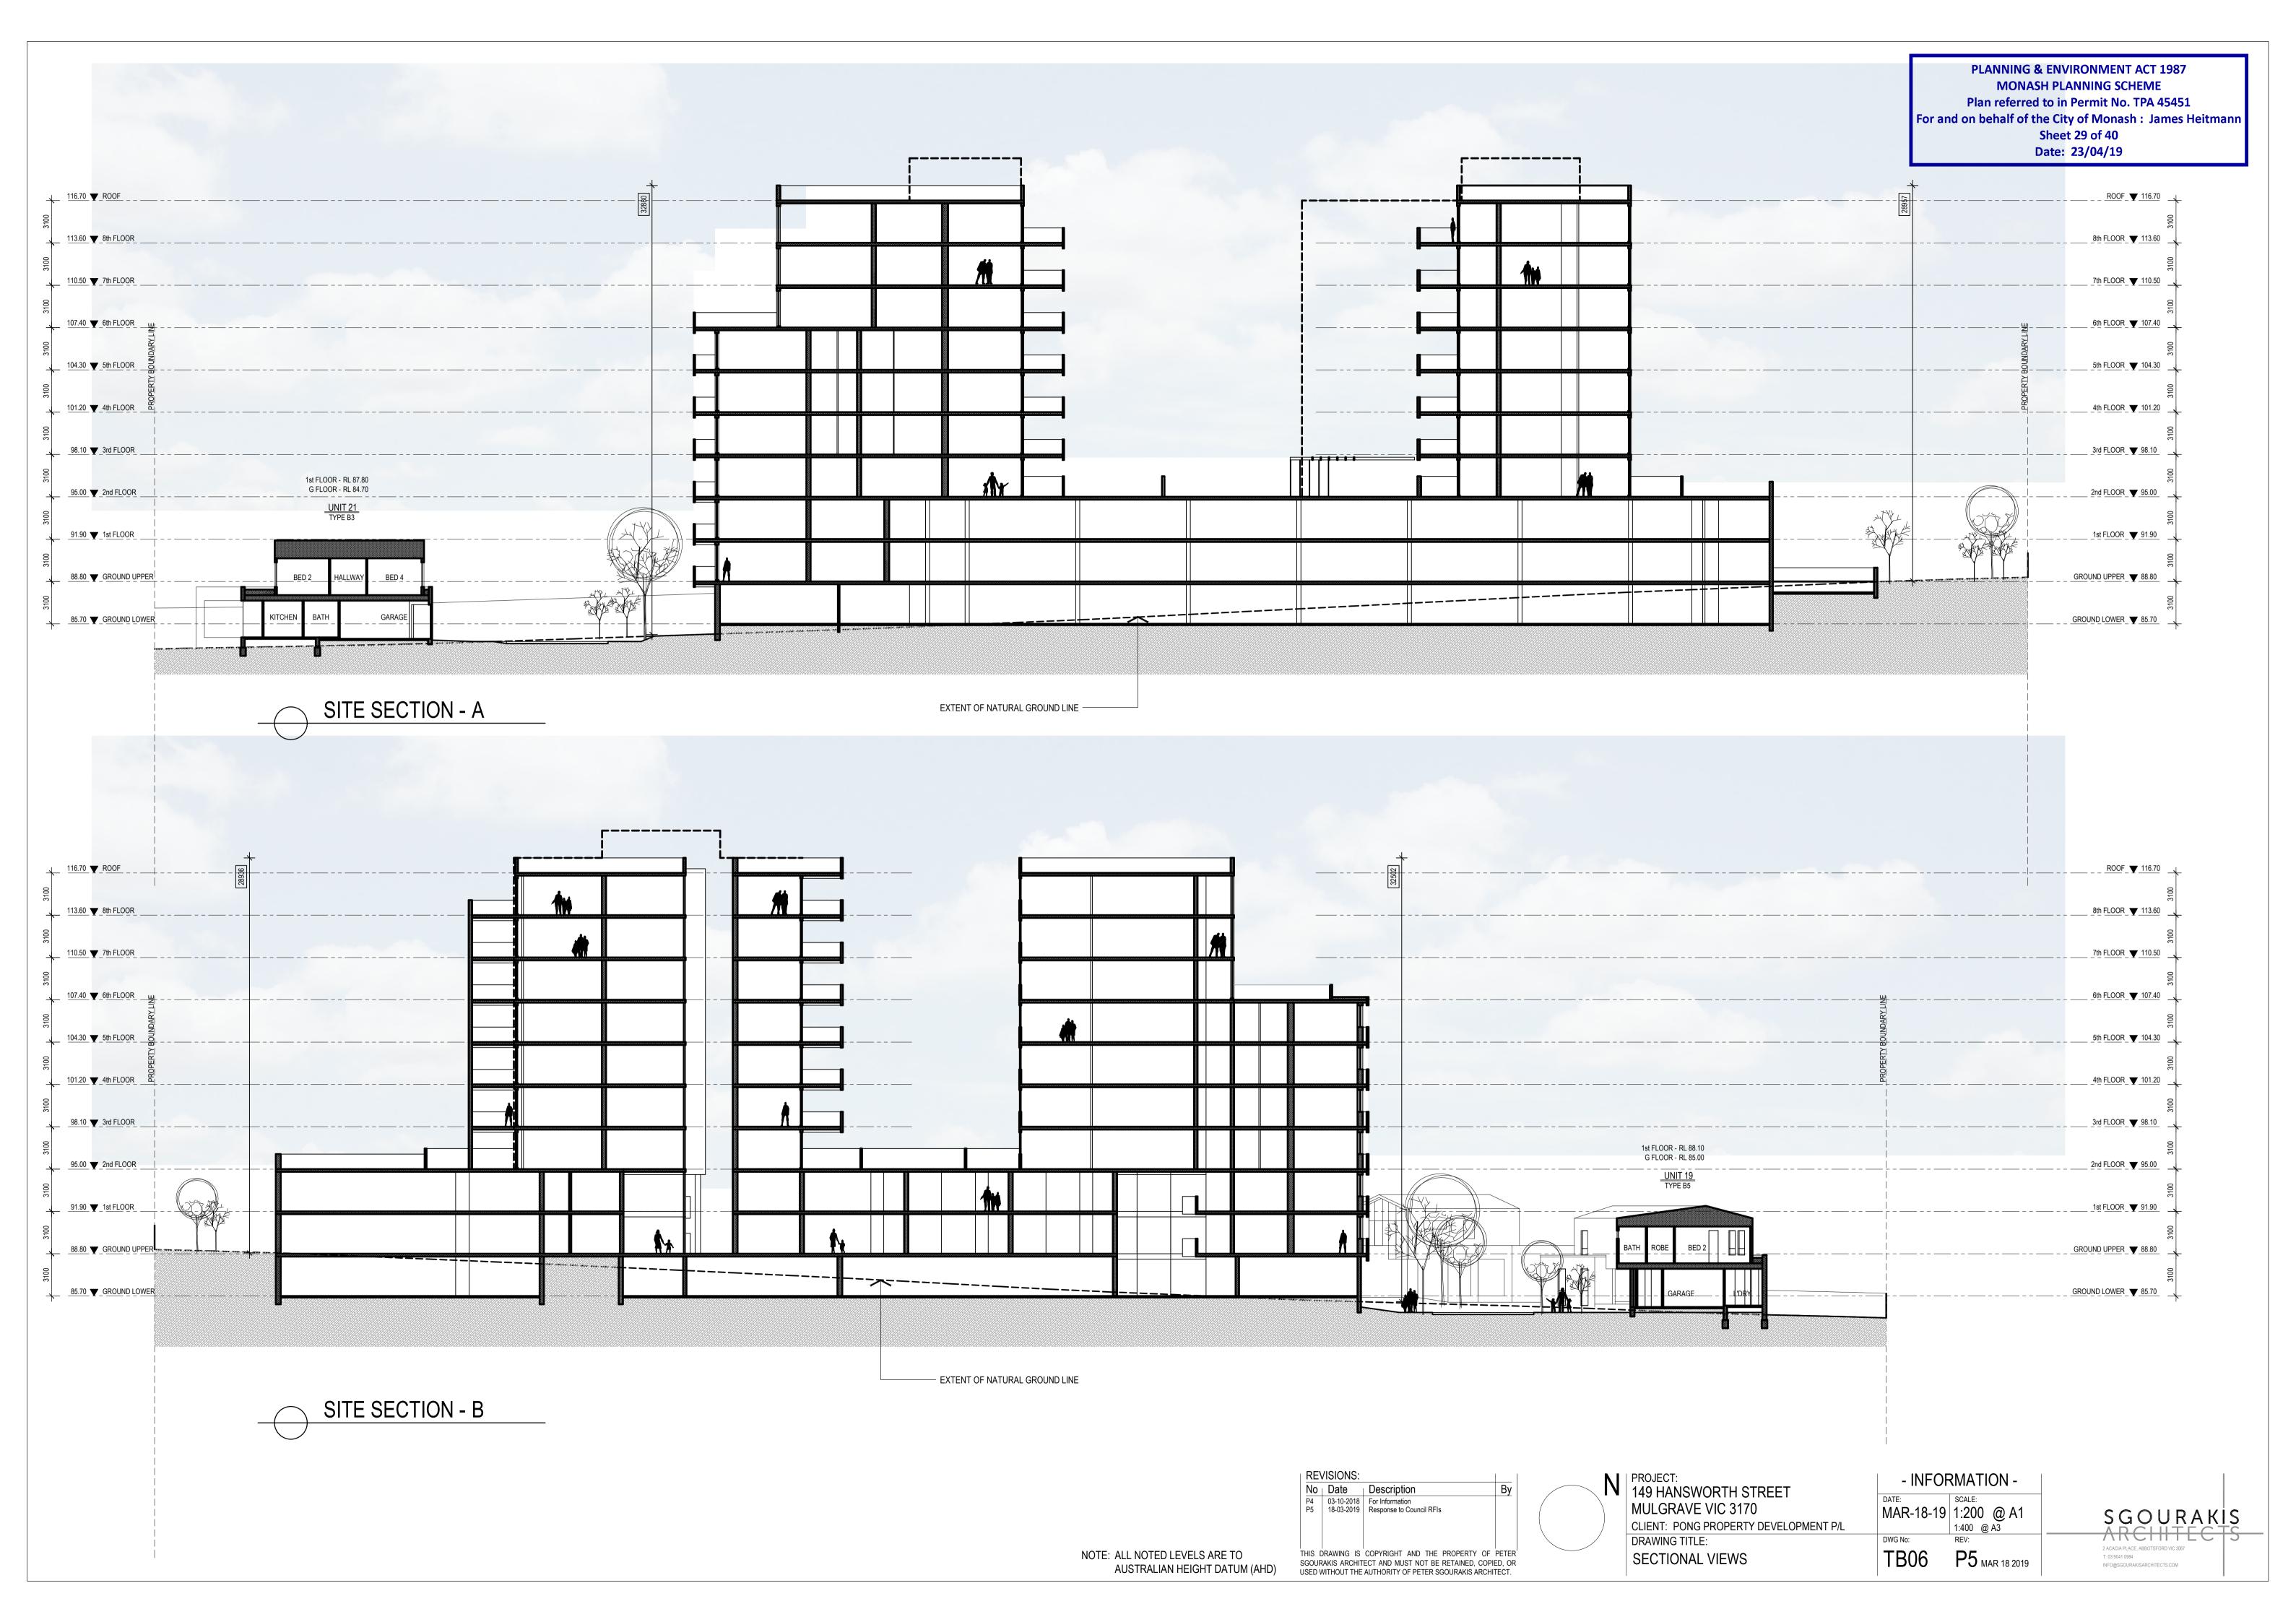

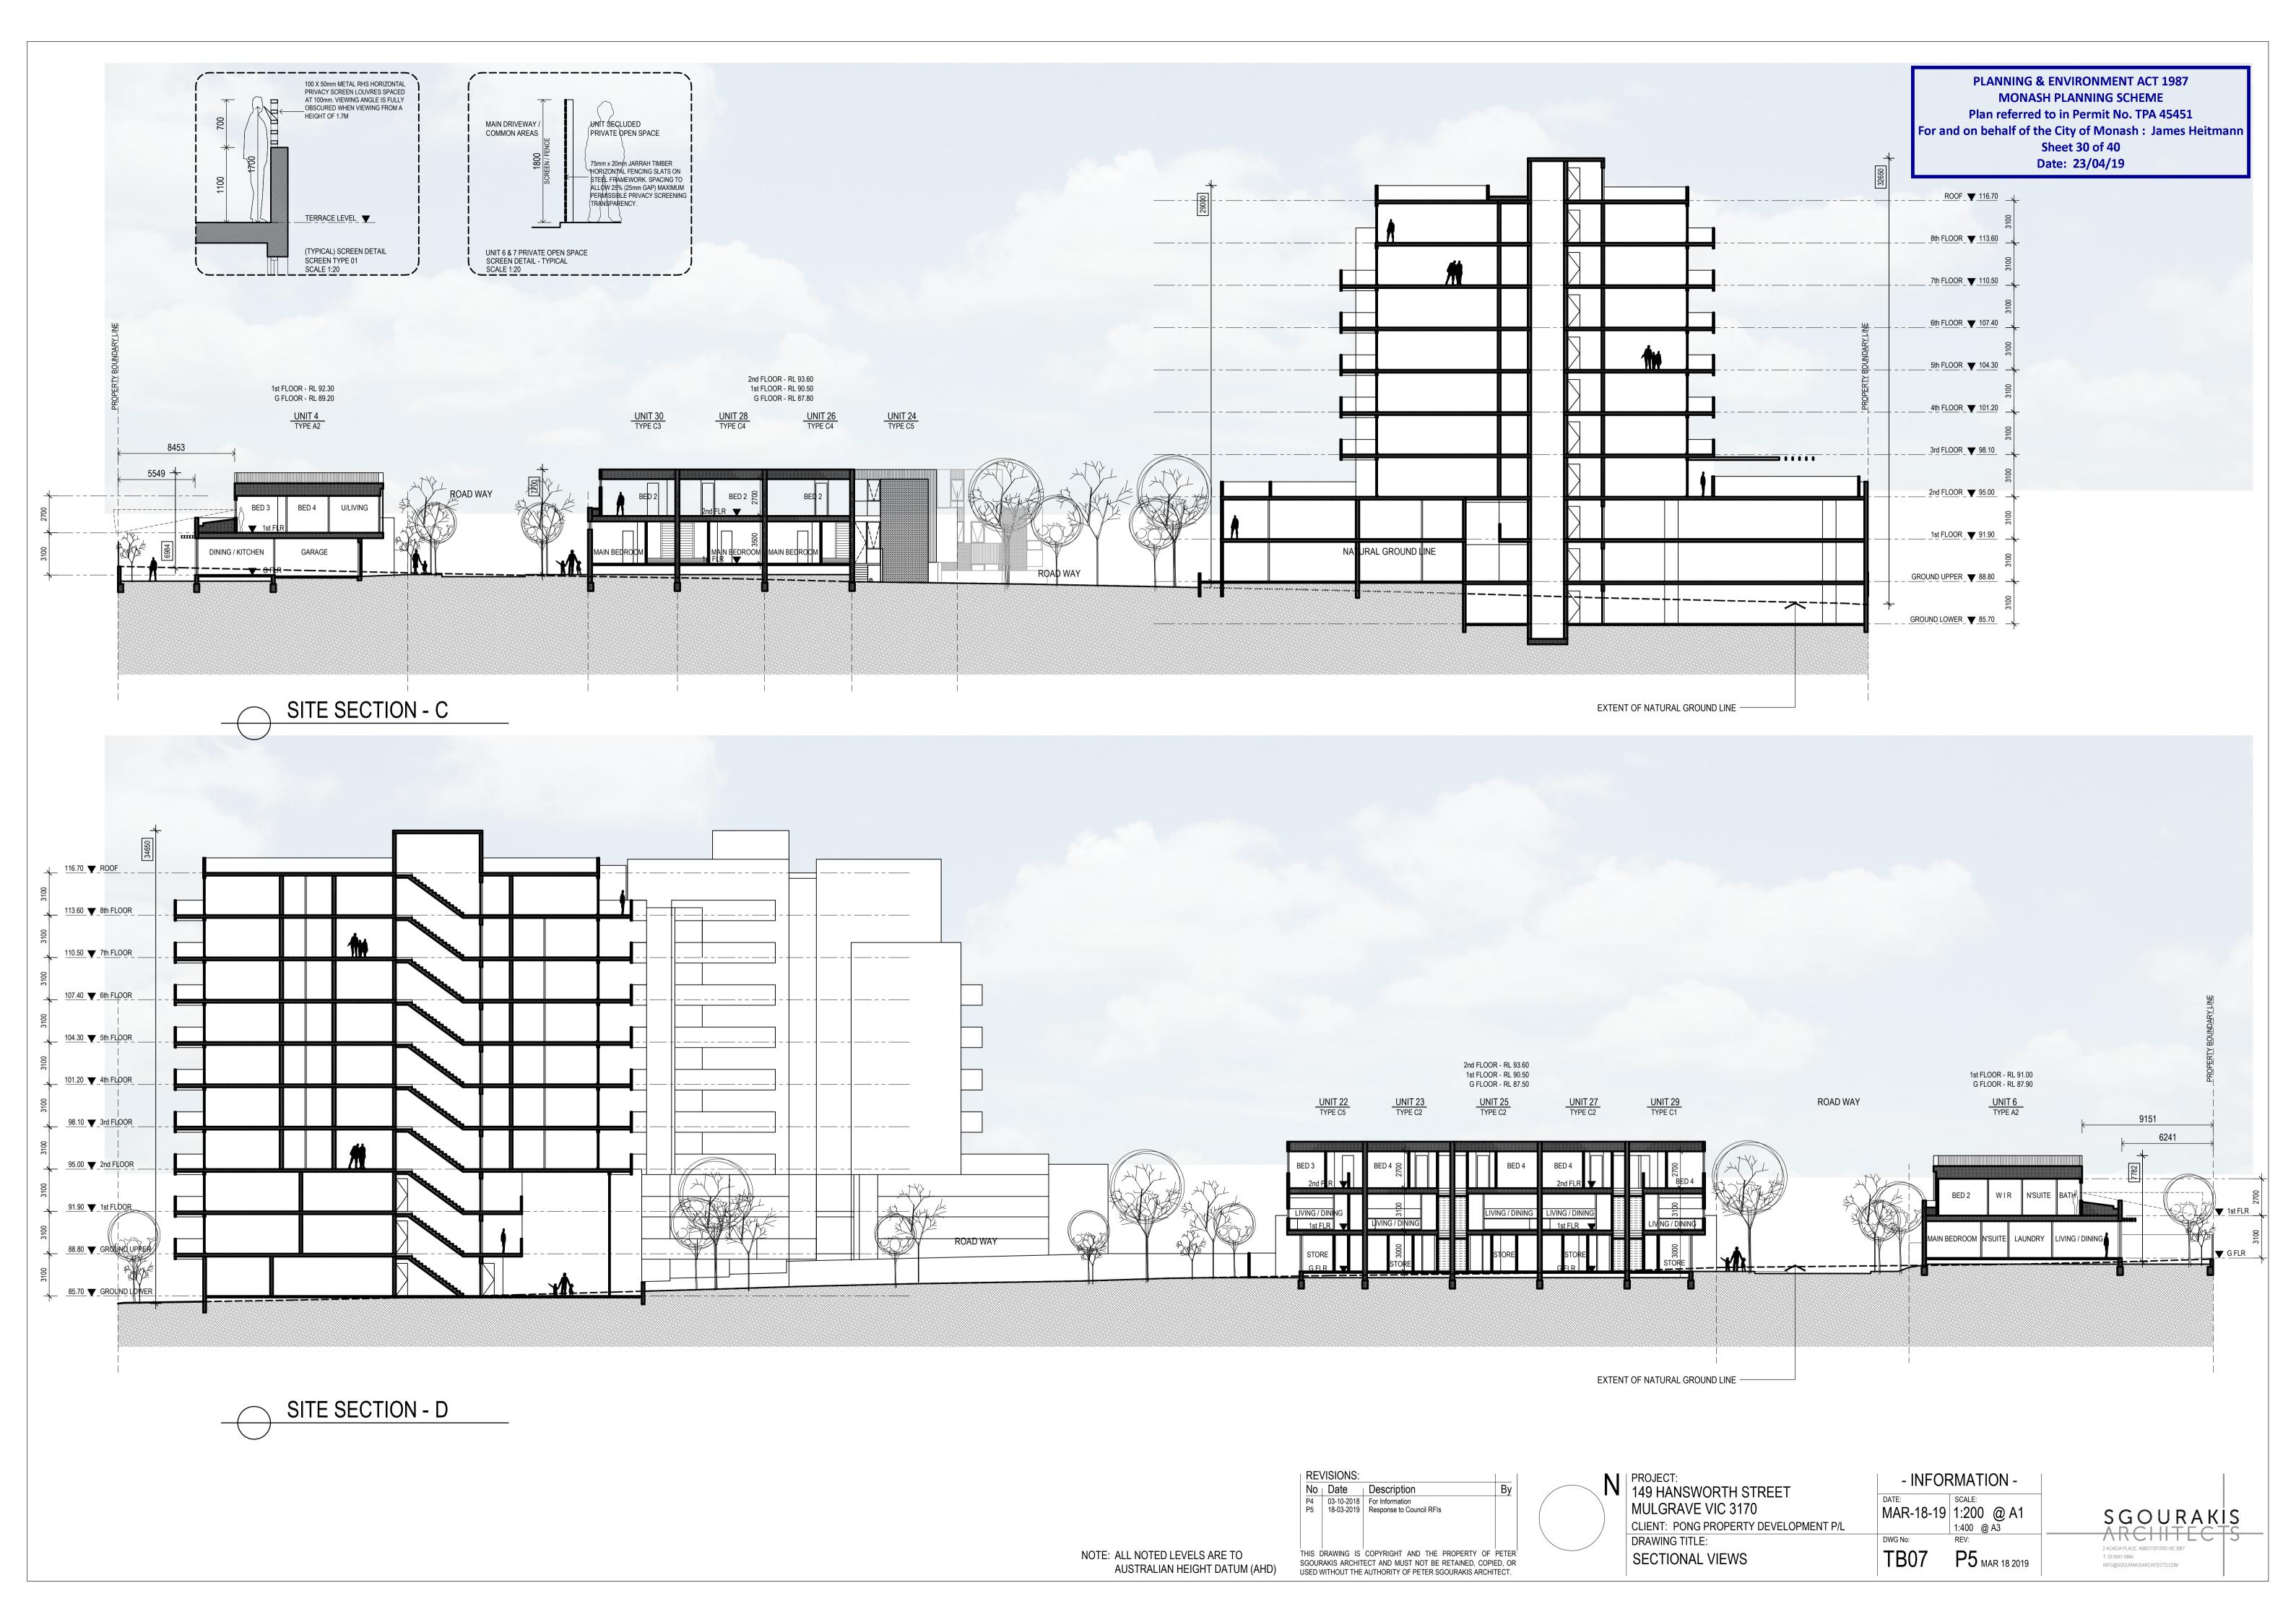

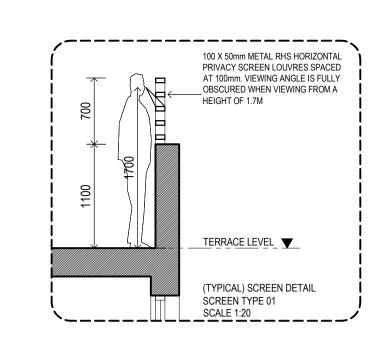

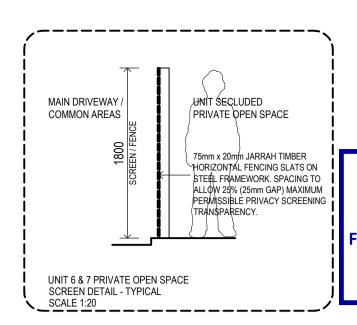

PLANNING & ENVIRONMENT ACT 1987

MONASH PLANNING SCHEME


Plan referred to in Permit No. TPA 45451

For and on behalf of the City of Monash: James Heitmann

Sheet 31 of 40

Date: 23/04/19



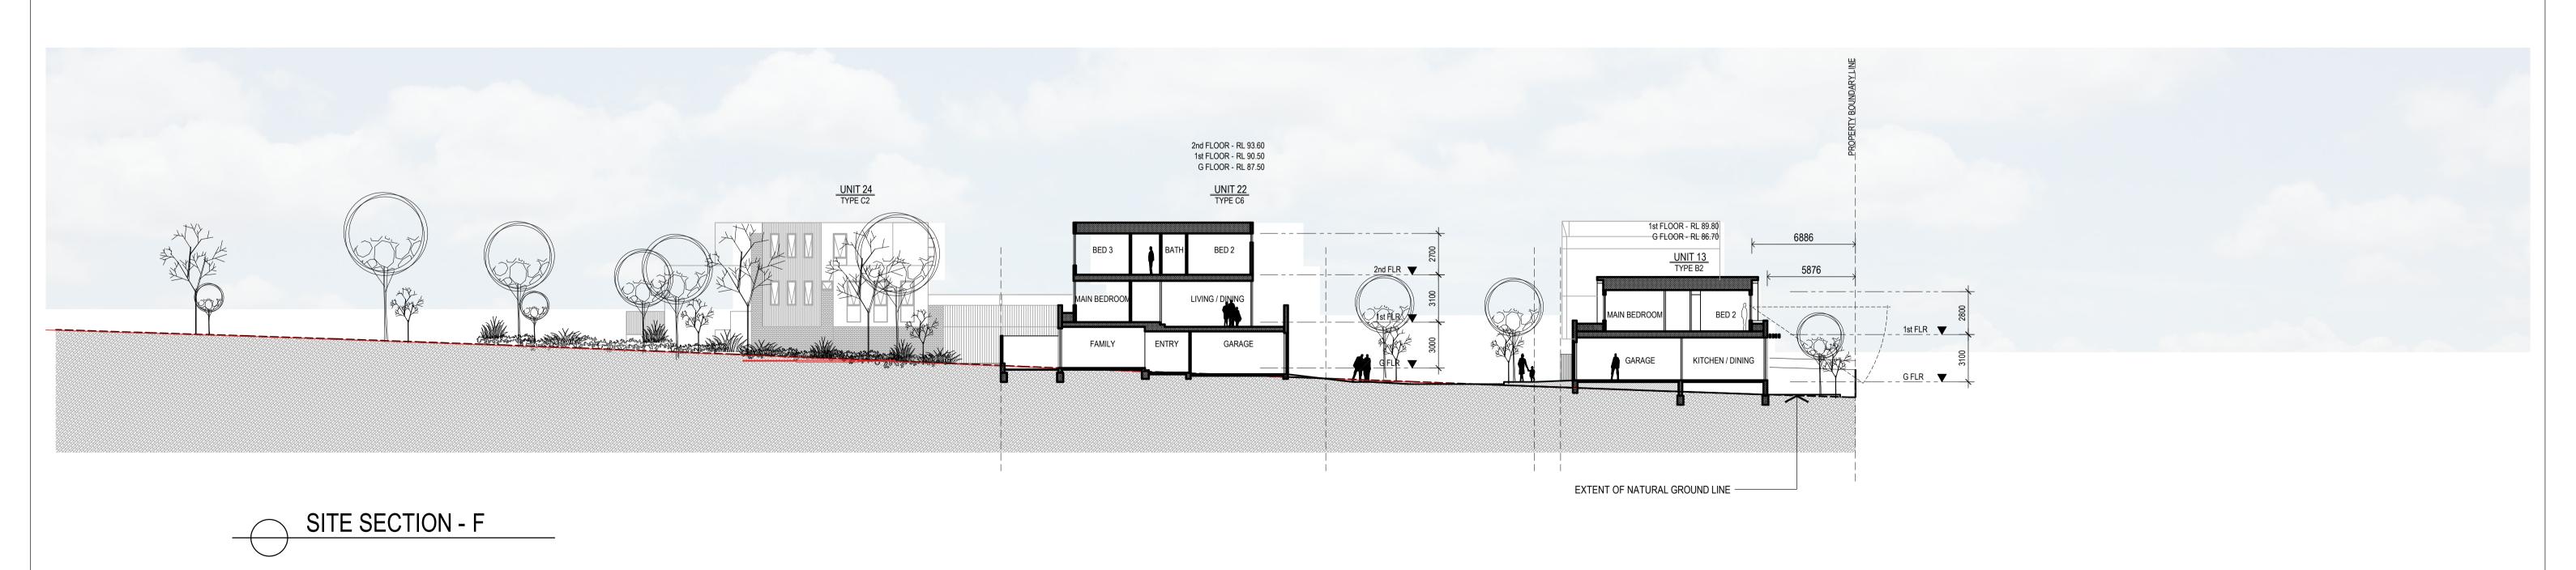

NOTE: ALL NOTED LEVELS ARE TO

AUSTRALIAN HEIGHT DATUM (AHD)

REVISIONS:

No Date Description

P4 03-10-2018 For Information Response to Council RFIs

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N PROJECT: 149 HANSWORTH STREET

MULGRAVE VIC 3170

SECTIONAL VIEWS

DRAWING TITLE:

CLIENT: PONG PROPERTY DEVELOPMENT P/L

- INFORMATION -


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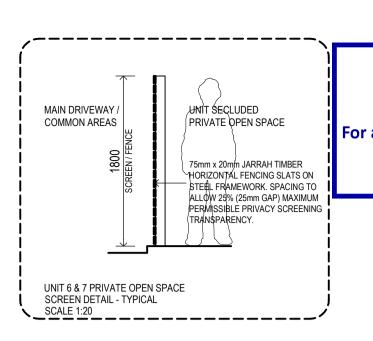
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T: 03 9041 0984 INFO@SGOURAKISARCHITECTS.COM

MAR-18-19 1:200 @ A1

TB08 P5 MAR 18 2019



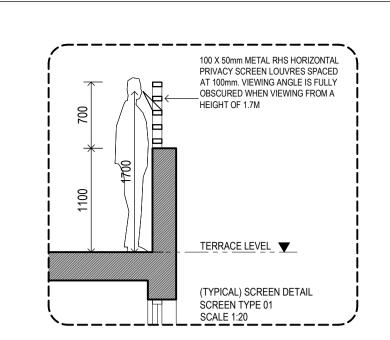

PLANNING & ENVIRONMENT ACT 1987


MONASH PLANNING SCHEME


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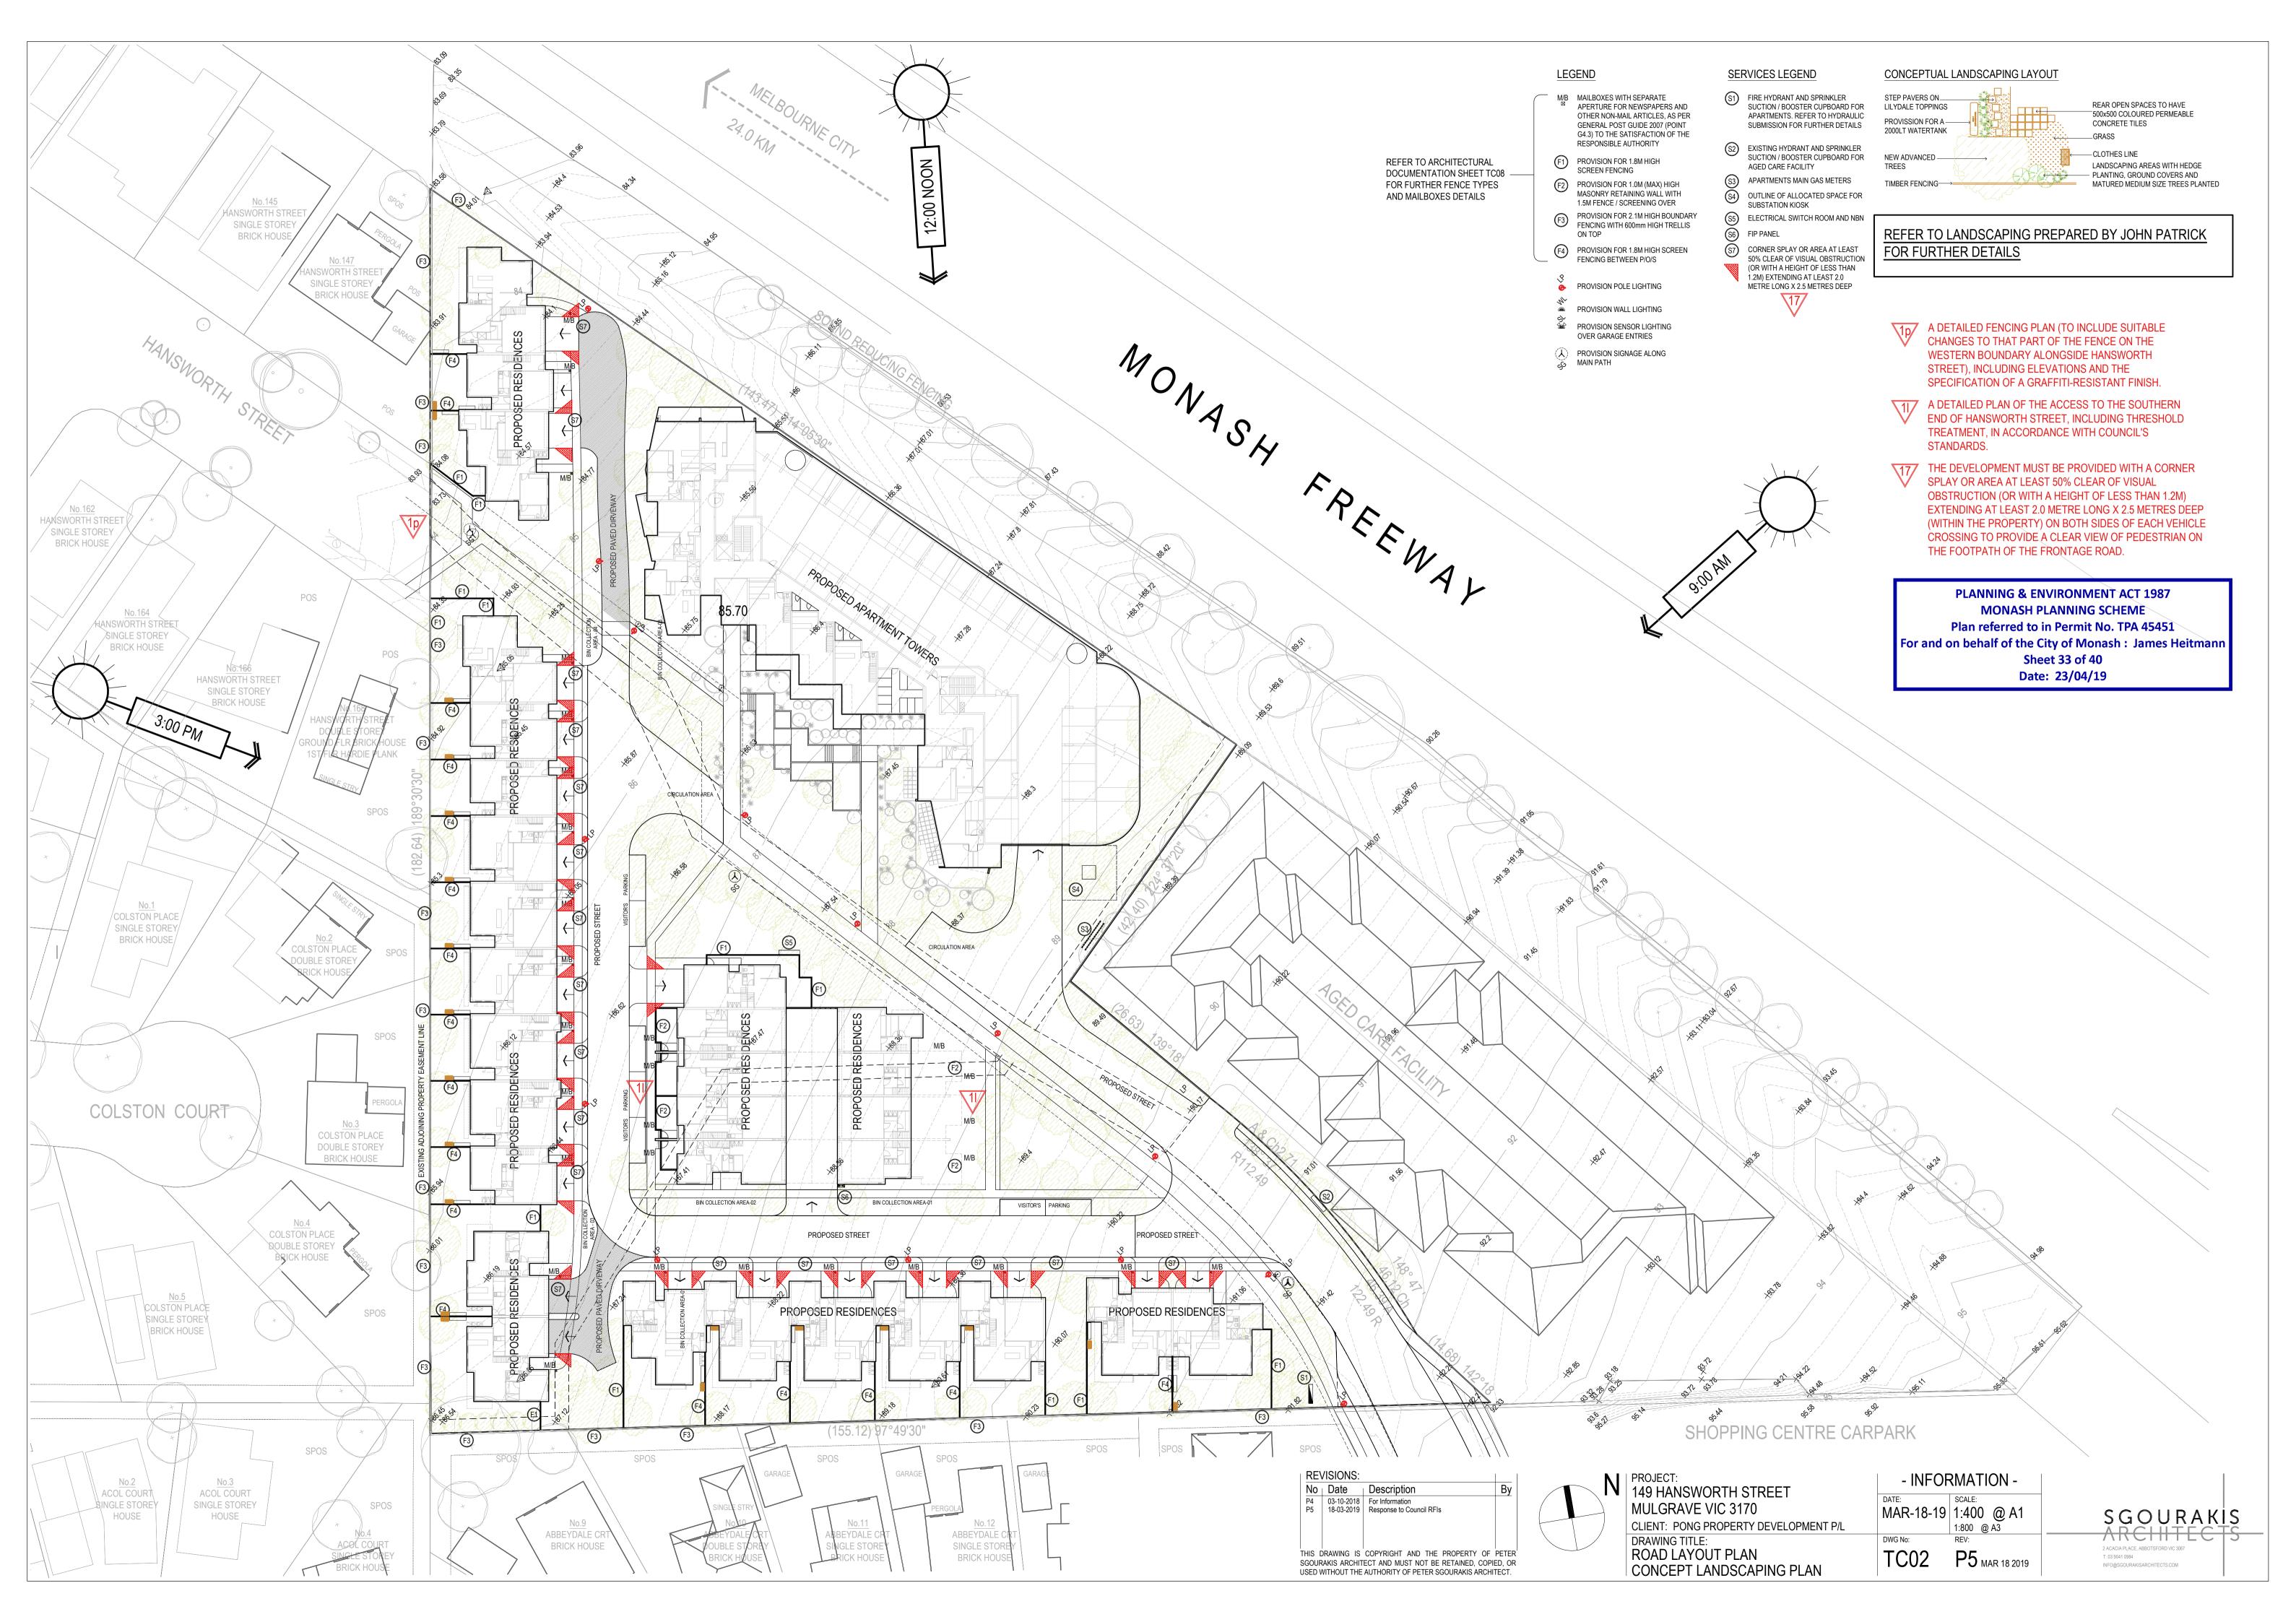
For and on behalf of the City of Monash: James Heitmann

Sheet 32 of 40

Date: 23/04/19



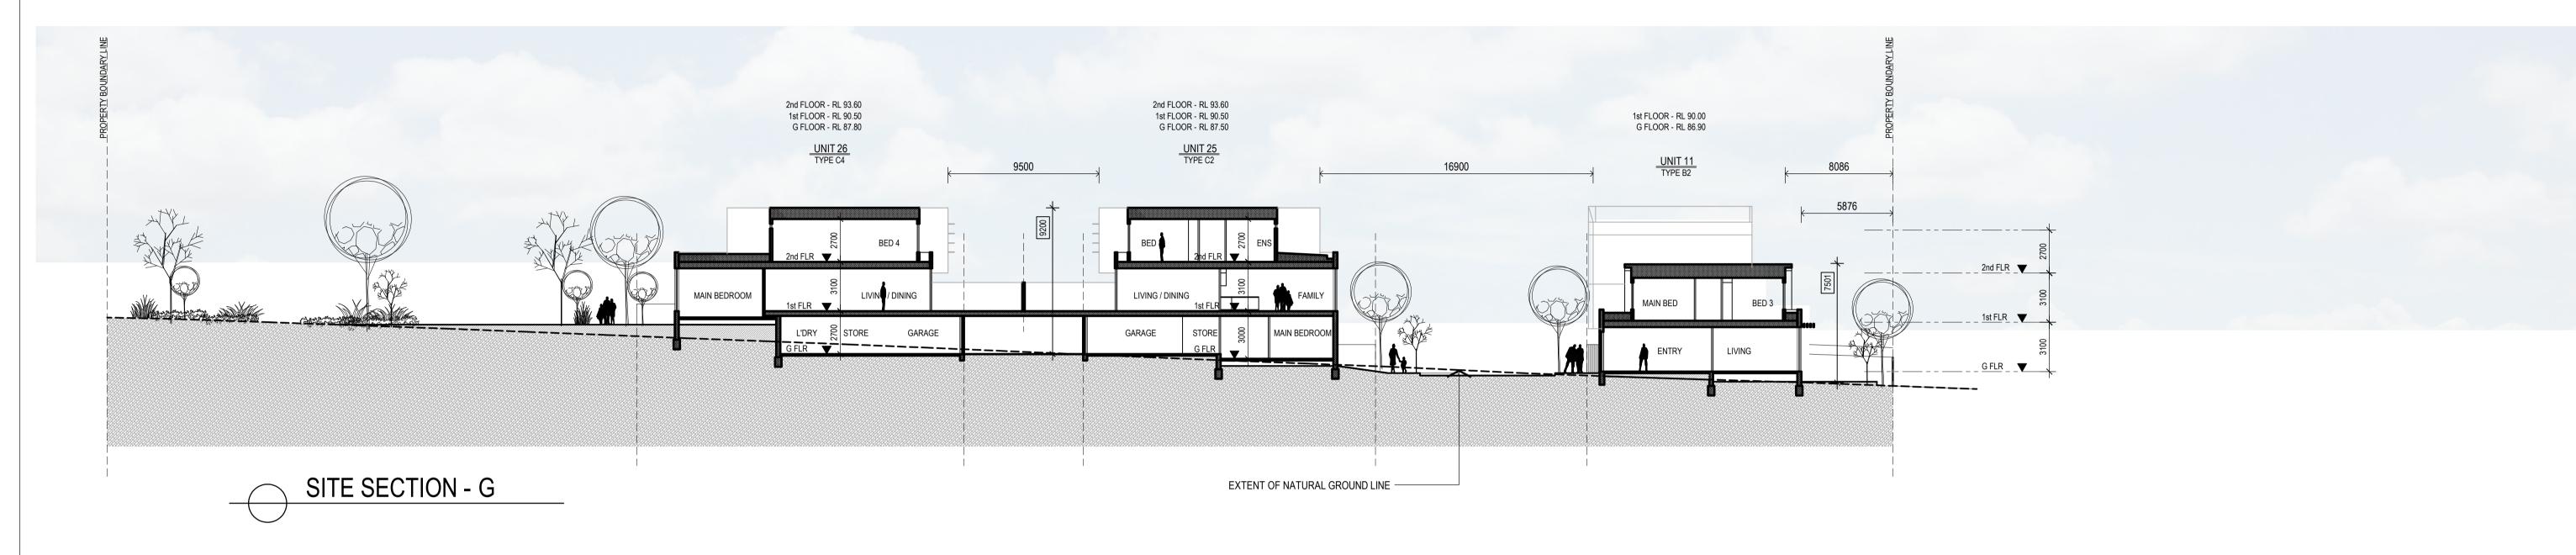

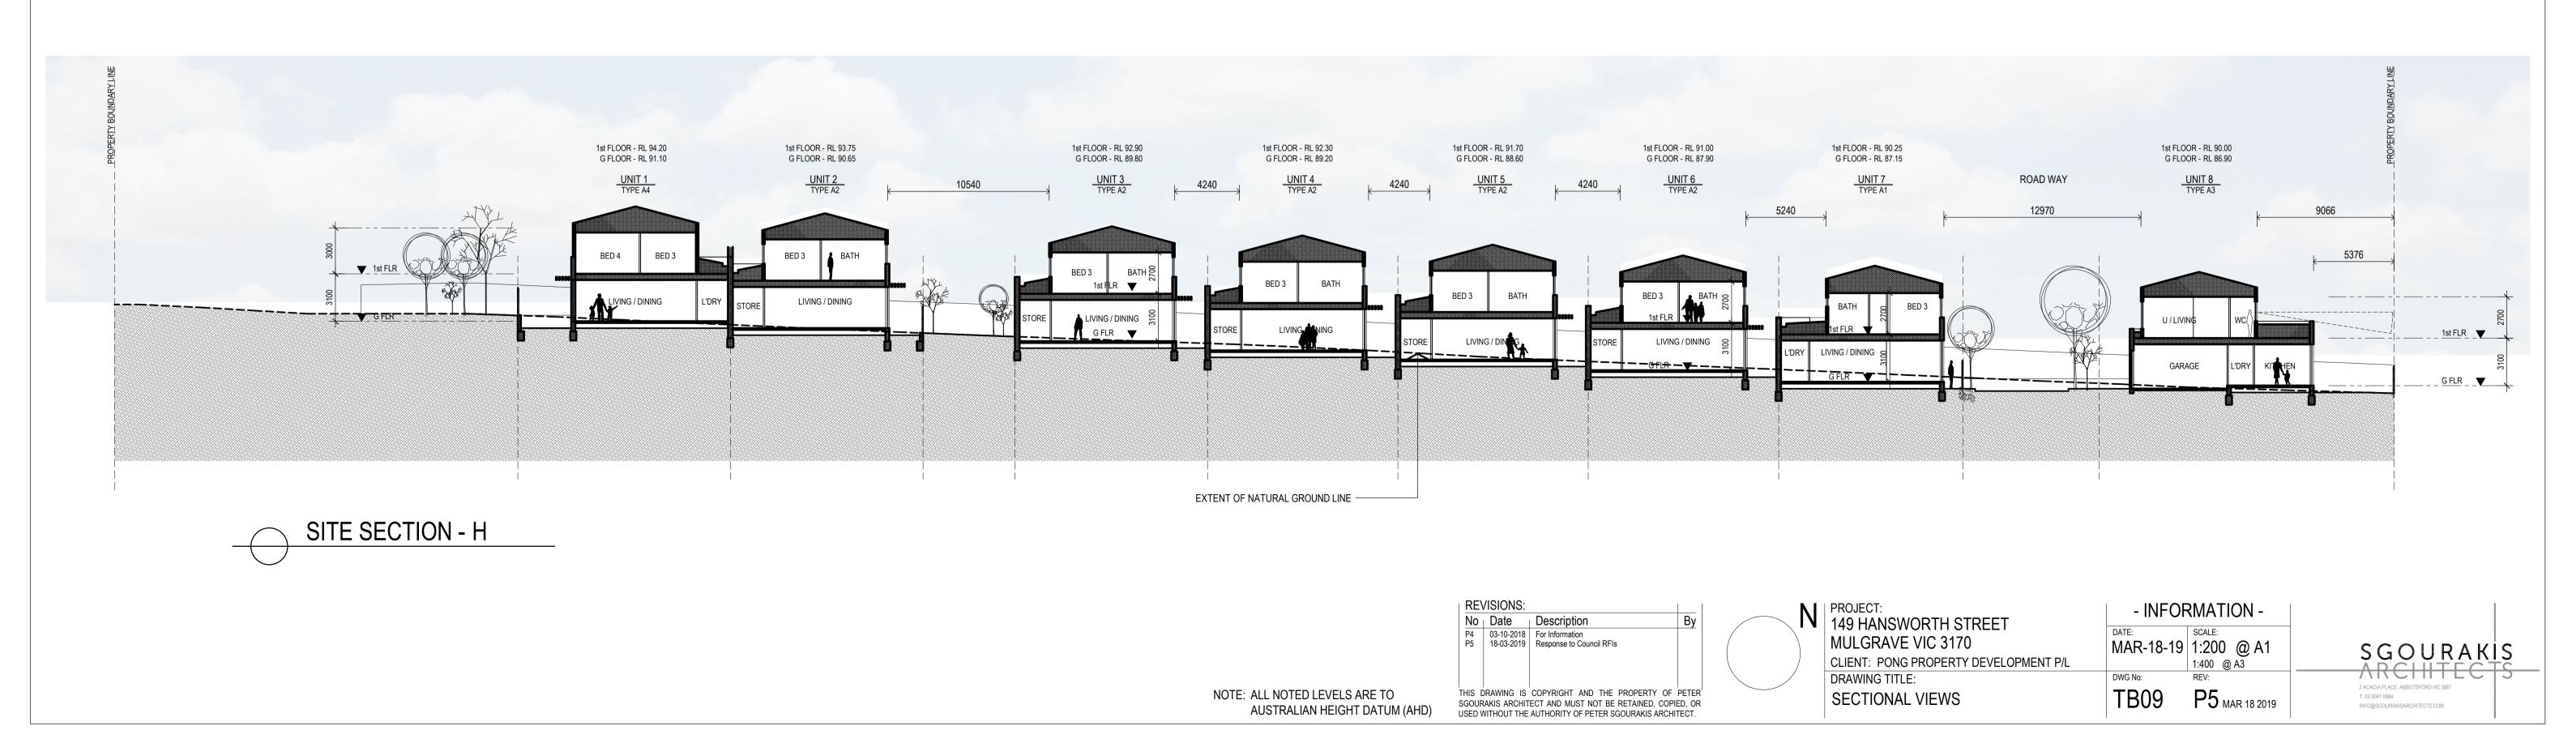

MATERIALS & COLOUR SCHEDULE - RESIDENTIAL UNITS

JAMES HARDIE FC SHEET WALL PANELS SELECT PAINT FINISH

• 8

FC SHEET "EXPRESSED-JOINT"

- ALUMINIUM WINDOW

FRAMING

WALL PANELS SELECT PAINT FINISH

GARAGE DOOR TYPES

9

REBATED VERTICAL WALL PANELS

- EXTENDED SILL SURROUND TO

SELECT PAINT FINISH

WINDOWS

TIMBER FINISH GARAGE DOOR PERFORATED GARAGE DOORS (UNDERCROFT AREA)

11

TEXTURED WALL PANELS

TIMBER FINISH EXTERNAL CLADDING (11)

SELECT PAINT FINISH

FACE BRICKWORK

- RENDERED SURFACES

- REBATED CLADDING

- FC SHEET PANELS

BRAHMAN GRANITE

3 DULUX NATURAL WHITE

4 DULUX GUILD GREY

5 DULUX WHITE DUCK

BRICK WORK 1

BOWRAL BRICKS OR SIMILAR

2 SIMMENTAL SILVER

- BRICK WORK 2

BOWRAL BRICKS OR SIMILAR

> **PLANNING & ENVIRONMENT ACT 1987 MONASH PLANNING SCHEME** Plan referred to in Permit No. TPA 45451 For and on behalf of the City of Monash: James Heitmann **Sheet 34 of 40** Date: 23/04/19

6 COLORBOND IRONSTONE

- WINDOWS FRAMES




COLORBOND WINDSPRAY

- CANOPY ROOFING
- METAL WORKS
- DOWN PIPES



PICTURE FRAMING FACADE TO TERRACE UNITS WITH VERTICAL

SCREENING

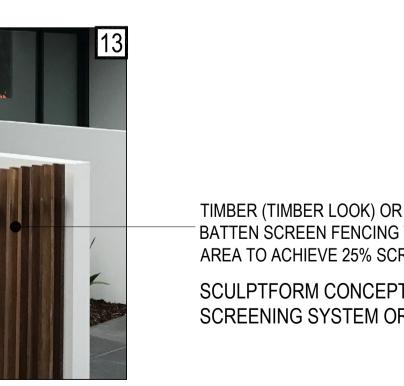

TIMBER (TIMBER LOOK) OR METAL UPRIGHT BATTEN SCREEN FENCING TO COURTYARD AREA TO ACHIEVE 25% SCREENING

SCULPTFORM CONCEPT CLICK SCREENING SYSTEM OR SIMILAR

HORIZONTAL WINDOW SCREENING

SCULPTFORM CONCEPT CLICK

SCREENING SYSTEM OR SIMILAR

TIMBER FINISH



TIMBER FINISH - EXTERNAL CLADDING

- EXTERNAL SCREENING

RADIAL TIMBER SHIPLAP FACADE SYSTEM OR SIMILAR


SCULPTFORM CONCEPT CLICK SCREENING SYSTEM OR SIMILAR



A DETAILED SCHEDULE OF ALL MATERIALS AND FINISHES INCLUDING SAMPLES, COLOURED ELEVATIONS AND PERSPECTIVES. THE FACADES OF THE TOWER BUILDINGS MUST CONFIRM THE GLASS AND OTHER REFLECTIVE MATERIALS MEET THE RELEVANT EPA STANDARD FOR GLARE.

> NOTE: GLAZING AND FACADE ELEMENTS TO THE TOWER TO BE IN ACCORDANCE WITH ANY BUILDING REGULATIONS RELATING TO EPA STANDARDS FOR GLARE.



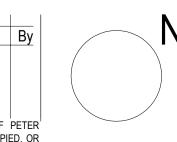

N PROJECT: 149 HANSWORTH STREET **MULGRAVE VIC 3170** CLIENT: PONG PROPERTY DEVELOPMENT P/L DRAWING TITLE: MATERIALS & COLOUR

SCHEDULE - RESIDENTIAL UNITS

- INFORMATION -MAR-18-19 P5 MAR 18 2019

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MATERIALS & COLOUR SCHEDULE - TOWER APARTMENTS

DULUX NATURAL WHITE

COLORBOND IRONSTONE



COLORBOND WINDSPRAY



- CANOPY ROOFING
- METAL WORKS
- DOWN PIPES

TIMBER FINISH


- EXTERNAL CLADDING
- EXTERNAL SCREENING

SCULPTFORM CONCEPT **CLICK SCREENING SYSTEM** OR SIMILAR







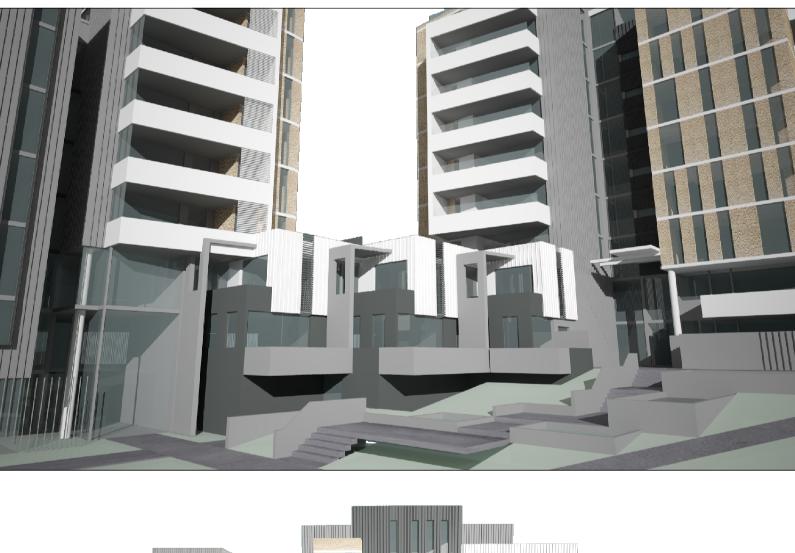



A DETAILED SCHEDULE OF ALL MATERIALS AND FINISHES INCLUDING SAMPLES, COLOURED ELEVATIONS AND PERSPECTIVES. THE FACADES OF THE TOWER BUILDINGS MUST CONFIRM THE GLASS AND OTHER REFLECTIVE MATERIALS MEET THE RELEVANT EPA STANDARD FOR

> NOTE: GLAZING AND FACADE ELEMENTS TO THE TOWER TO BE IN ACCORDANCE WITH ANY BUILDING REGULATIONS RELATING TO EPA STANDARDS FOR GLARE.




TEXTURED WALL 1

TOWER WALLS FEATURE TEXTURED PANEL WALL SURFACE -**COLOUR TO MATCH DULUX STONEBREAD** S15E2 (OR APPROVED EQUIVALENT)



25 VITRACORE - G2 LIGHT GREY

- CLADDING / LINING TO CANOPY AND ASSOCIATED ENTRANCE STRUCTURE

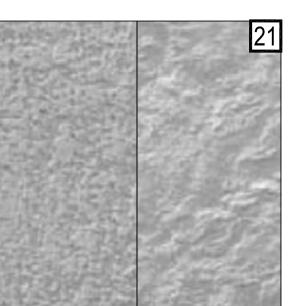

TEXTURED WALL 2

- TOWER WALLS APPLIED DULUX ACRATEX FINISH (OR APPROVED EQUIVALENT) TO NOTED COLOUR



- CLADDING / LINING TO CANOPY AND ASSOCIATED ENTRANCE STRUCTURE



FEATURE WALL

EXTERNAL FEATURE WALL **CAR PARKING PODIUM** MULTI-COLOURED BLADE/BATTEN LOUVRED FACADE SYSTEM

23 PRECAST PANELS

TOWER WALLS (RIBBED)

NATURAL CONCRETE FINISH (UNLESS NOTED OTHERWISE)



SOLID BALUSTRADING -TO TERRACE AREAS

TO OUTDOOR OPEN SPACES



GLAZED PARTITION PANELS




GLAZED BALUSTRADING -TO TERRACES



METAL SCREENING

PLANNING & ENVIRONMENT ACT 1987 MONASH PLANNING SCHEME Plan referred to in Permit No. TPA 45451 For and on behalf of the City of Monash: James Heitmann **Sheet 35 of 40** Date: 23/04/19

- PRECAST WALL PANELS RENDERED FINISH / NATURAL FINISH

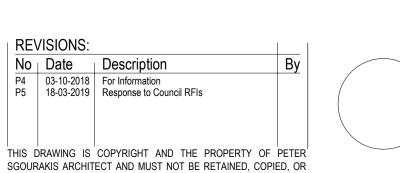


N PROJECT: 149 HANSWORTH STREET **MULGRAVE VIC 3170** CLIENT: PONG PROPERTY DEVELOPMENT P/L

DRAWING TITLE: MATERIALS & COLOUR SCHEDULE - TOWERS

- INFORMATION -MAR-18-19

TC05a P5 MAR 18 2019


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FENCING TYPE - F1
ELEVATION (VIEW FROM PUBLIC/COMMUNAL AREA)
SCALE 1:20

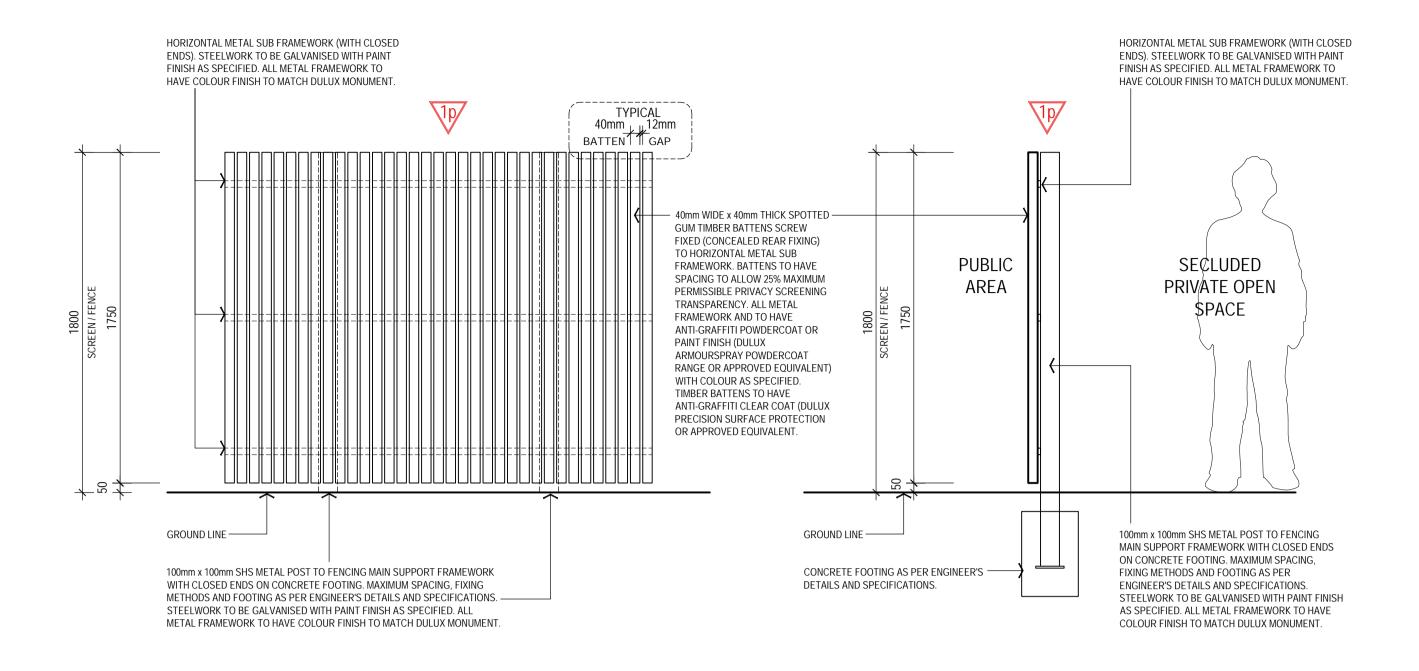
FENCING TYPE - F1
SECTION
SCALE 1:20

A DETAILED FENCING PLAN (TO INCLUDE SUITABLE CHANGES TO THAT PART OF THE FENCE ON THE WESTERN BOUNDARY ALONGSIDE HANSWORTH STREET), INCLUDING ELEVATIONS AND THE SPECIFICATION OF A GRAFFITI-RESISTANT FINISH.



FENCING TYPE - F4
ELEVATION
SCALE 1:20

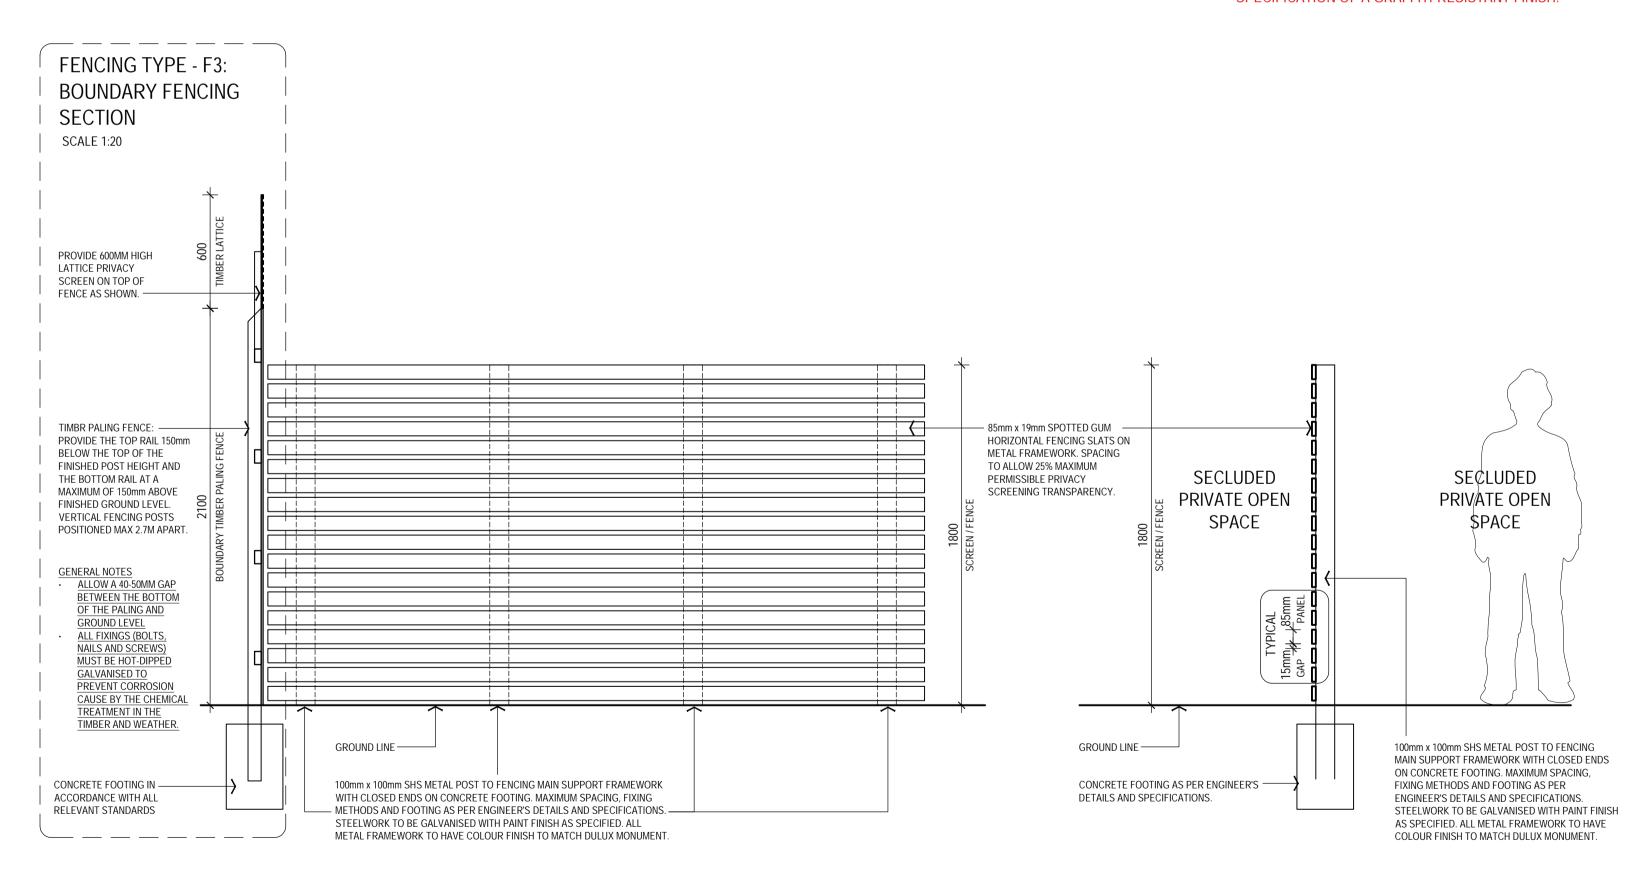FENCING TYPE - F4
ELEVATION
SCALE 1:20

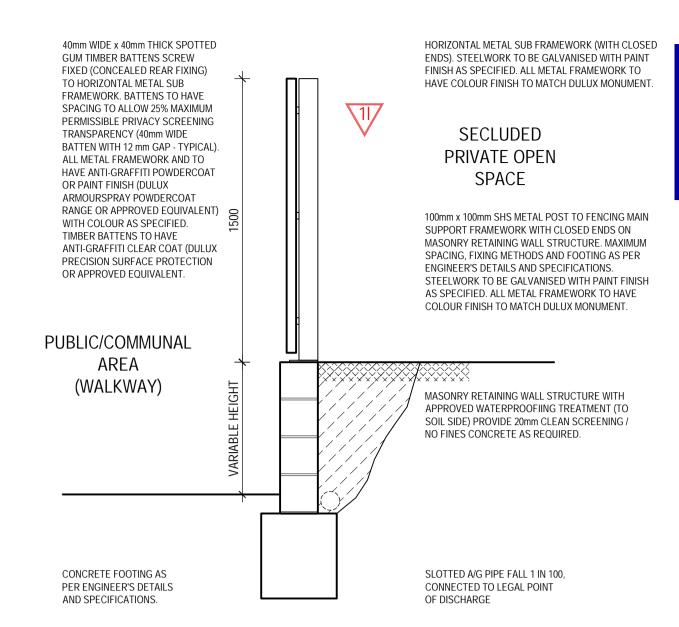

PLANNING & ENVIRONMENT ACT 1987

MONASH PLANNING SCHEME

Plan referred to in Permit No. TPA 45451


For and on behalf of the City of Monash: James Heitmann

Sheet 36 of 40

Date: 23/04/19

FENCING TYPE - F2 SECTION SCALE 1:20

A DETAILED PLAN OF THE ACCESS TO THE SOUTHERN END OF HANSWORTH STREET, INCLUDING THRESHOLD TREATMENT, IN ACCORDANCE WITH COUNCIL'S STANDARDS.

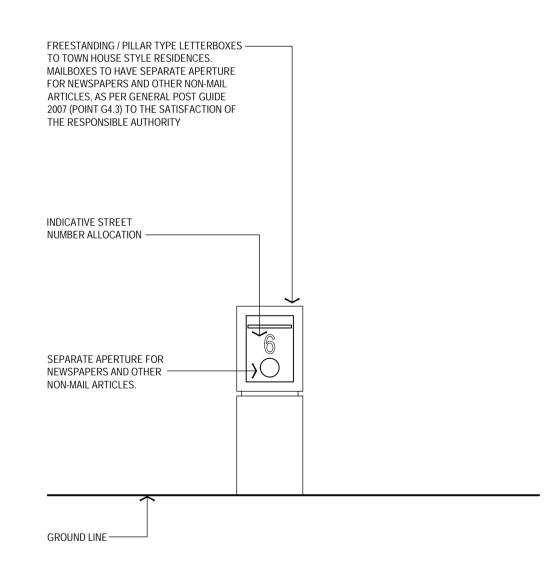

M/B - MAILBOX ELEVATION (INDICATIVE ONLY) G4.3.2 – SIZE OF MAIL BOXES

AUSTRALIA POST DELIVERS ONLY INTO MAIL BOXES OF AN APPROVED SIZE. MAIL BOX APERTURES MAY BE EITHER HORIZONTAL OR VERTICAL. AUSTRALIA POST RECOMMENDS A SEPARATE APERTURE, BOX OR TUBE TO ACCOMMODATE NEWSPAPERS AND NONMAIL ARTICLES.

DIMENSION APPROVED SIZE

INTERNAL WIDTH (LEFT TO RIGHT) AT LEAST 230 MM
INTERNAL DEPTH (FRONT TO BACK) AT LEAST 330 MM
INTERNAL HEIGHT AT LEAST 160 MM

HORIZONTAL APERTURE
VERTICAL APERTURE
AT LEAST 230 MM X 30 MM. AT LEAST 130 MM ABOVE INTERNAL BASE
AT LEAST 330 MM X 30 MM. AT LEAST 40 MM ABOVE INTERNAL BASE
SINGLE MAIL BOX – BETWEEN 900 MM AND 1200 MM
GROUP OF MAILBOXES – BETWEEN 600 MM AND 1600 MM

G4.3.3 – LOCATION OF MAIL BOXES
AUSTRALIA POST DELIVERS ONLY INTO MAIL BOXES IN AN APP

AUSTRALIA POST DELIVERS ONLY INTO MAIL BOXES IN AN APPROVED LOCATION. MAIL BOXES MUST ALLOW UNHINDERED ACCESS TO THE DELIVERY APERTURE. THE TABLE SHOWS THE LOCATION REQUIREMENTS FOR MAIL BOXES DEPENDING ON THE TYPE OF PREMISES.

BICYCLE OR MOTOR CYCLE.

TYPE OF PREMISES

ES APPROVED LOCATION

SINGLE RESIDENTIAL OR COMMERCIAL PREMISES

A SINGLE MAIL BOX ON THE BOUNDARY OF THE PROPERTY WITH THE FOOTPATH OR ROAD. THE MAIL BOX APERTURE MUST FACE THE FOOTPATH OR ROAD. IF THE DOOR OF THE BUILDING ABUTS THE FOOTPATH, THE MAIL BOX APERTURE MAY BE IN THE DOOR. A POSTAL DELIVERY OFFICER MUST

BE ABLE TO PLACE MAIL IN THE BOX WITHOUT DISMOUNTING FROM A

SINGLE RESIDENTIAL OR BUSINESS PREMISES WITH DRIVEWAY ACCESS TO A ROAD

AT THE JUNCTION OF THE DRIVEWAY WITH THE ROAD.

TWO ADJOINING RESIDENTIAL OR BUSINESS PREMISES WITH COMMON DRIVEWAY ACCESS TO A ROAD

BOTH MAIL BOXES AT A COMMON POINT AT THE JUNCTION OF THE DRIVEWAY WITH THE ROAD.

PREMISES WITH MULTIPLE DELIVERY POINTS

A SINGLE GROUP OF MAIL BOXES ON THE BOUNDARY OF THE PROPERTY WITH THE FOOTPATH OR PUBLIC ROAD. THE MAIL BOXES MAY BE AT RIGHT ANGLES TO THE FOOTPATH OR ROAD AND PARALLEL TO THE DRIVEWAY WITH THE FIRST BOX AS CLOSE TO THE BOUNDARY AS POSSIBLE. ADEQUATE PARKING FOR A BICYCLE OR MOTOR CYCLE MUST BE AVAILABLE. A POSTAL DELIVERY OFFICER MUST BE ABLE TO PLACE MAIL IN THE BOXES SAFELY.

MULTI-STOREY RESIDENTIAL OR COMMERCIAL BUILDINGS

AS FOR PREMISES WITH MULTIPLE DELIVERY POINTS. IF THE ENTRANCE TO THE BUILDING ABUTS THE FOOTPATH OR ROAD, THE SINGLE GROUP OF MAIL BOXES MAY BE IN THE FOYER AS CLOSE TO THE ENTRANCE AS POSSIBLE. AUSTRALIA POST MAY REQUIRE A MAIL ROOM OR A MAIL LOCKER FOR THE USE OF POSTAL DELIVERY OFFICERS.

VERY LARGE MULTI-STOREY RESIDENTIAL OR COMMERCIAL BUILDINGS


A SINGLE GROUP OF MAIL BOXES LOCATED AT A CONVENIENT POINT WITH MOTOR VEHICLE ACCESS IN A SERVICE AREA OR BASEMENT. AUSTRALIA POST MAY REQUIRE A MAIL ROOM OR A MAIL LOCKER FOR THE USE OF POSTAL DELIVERY OFFICERS.

REVISIONS:

No Date Description By

P4 03-10-2018 For Information

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PROJECT:
149 HANSWORTH STREET
MULGRAVE VIC 3170
CLIENT: PONG PROPERTY DEVELOPMENT P/L
DRAWING TITLE:
FENCE TYPES & MAILBOXES

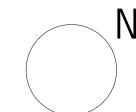
- INFORMATION
DATE: SCALE: @ A1


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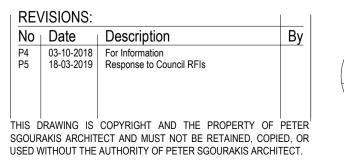
DWG NO: REV:

P4 oct 03 2018





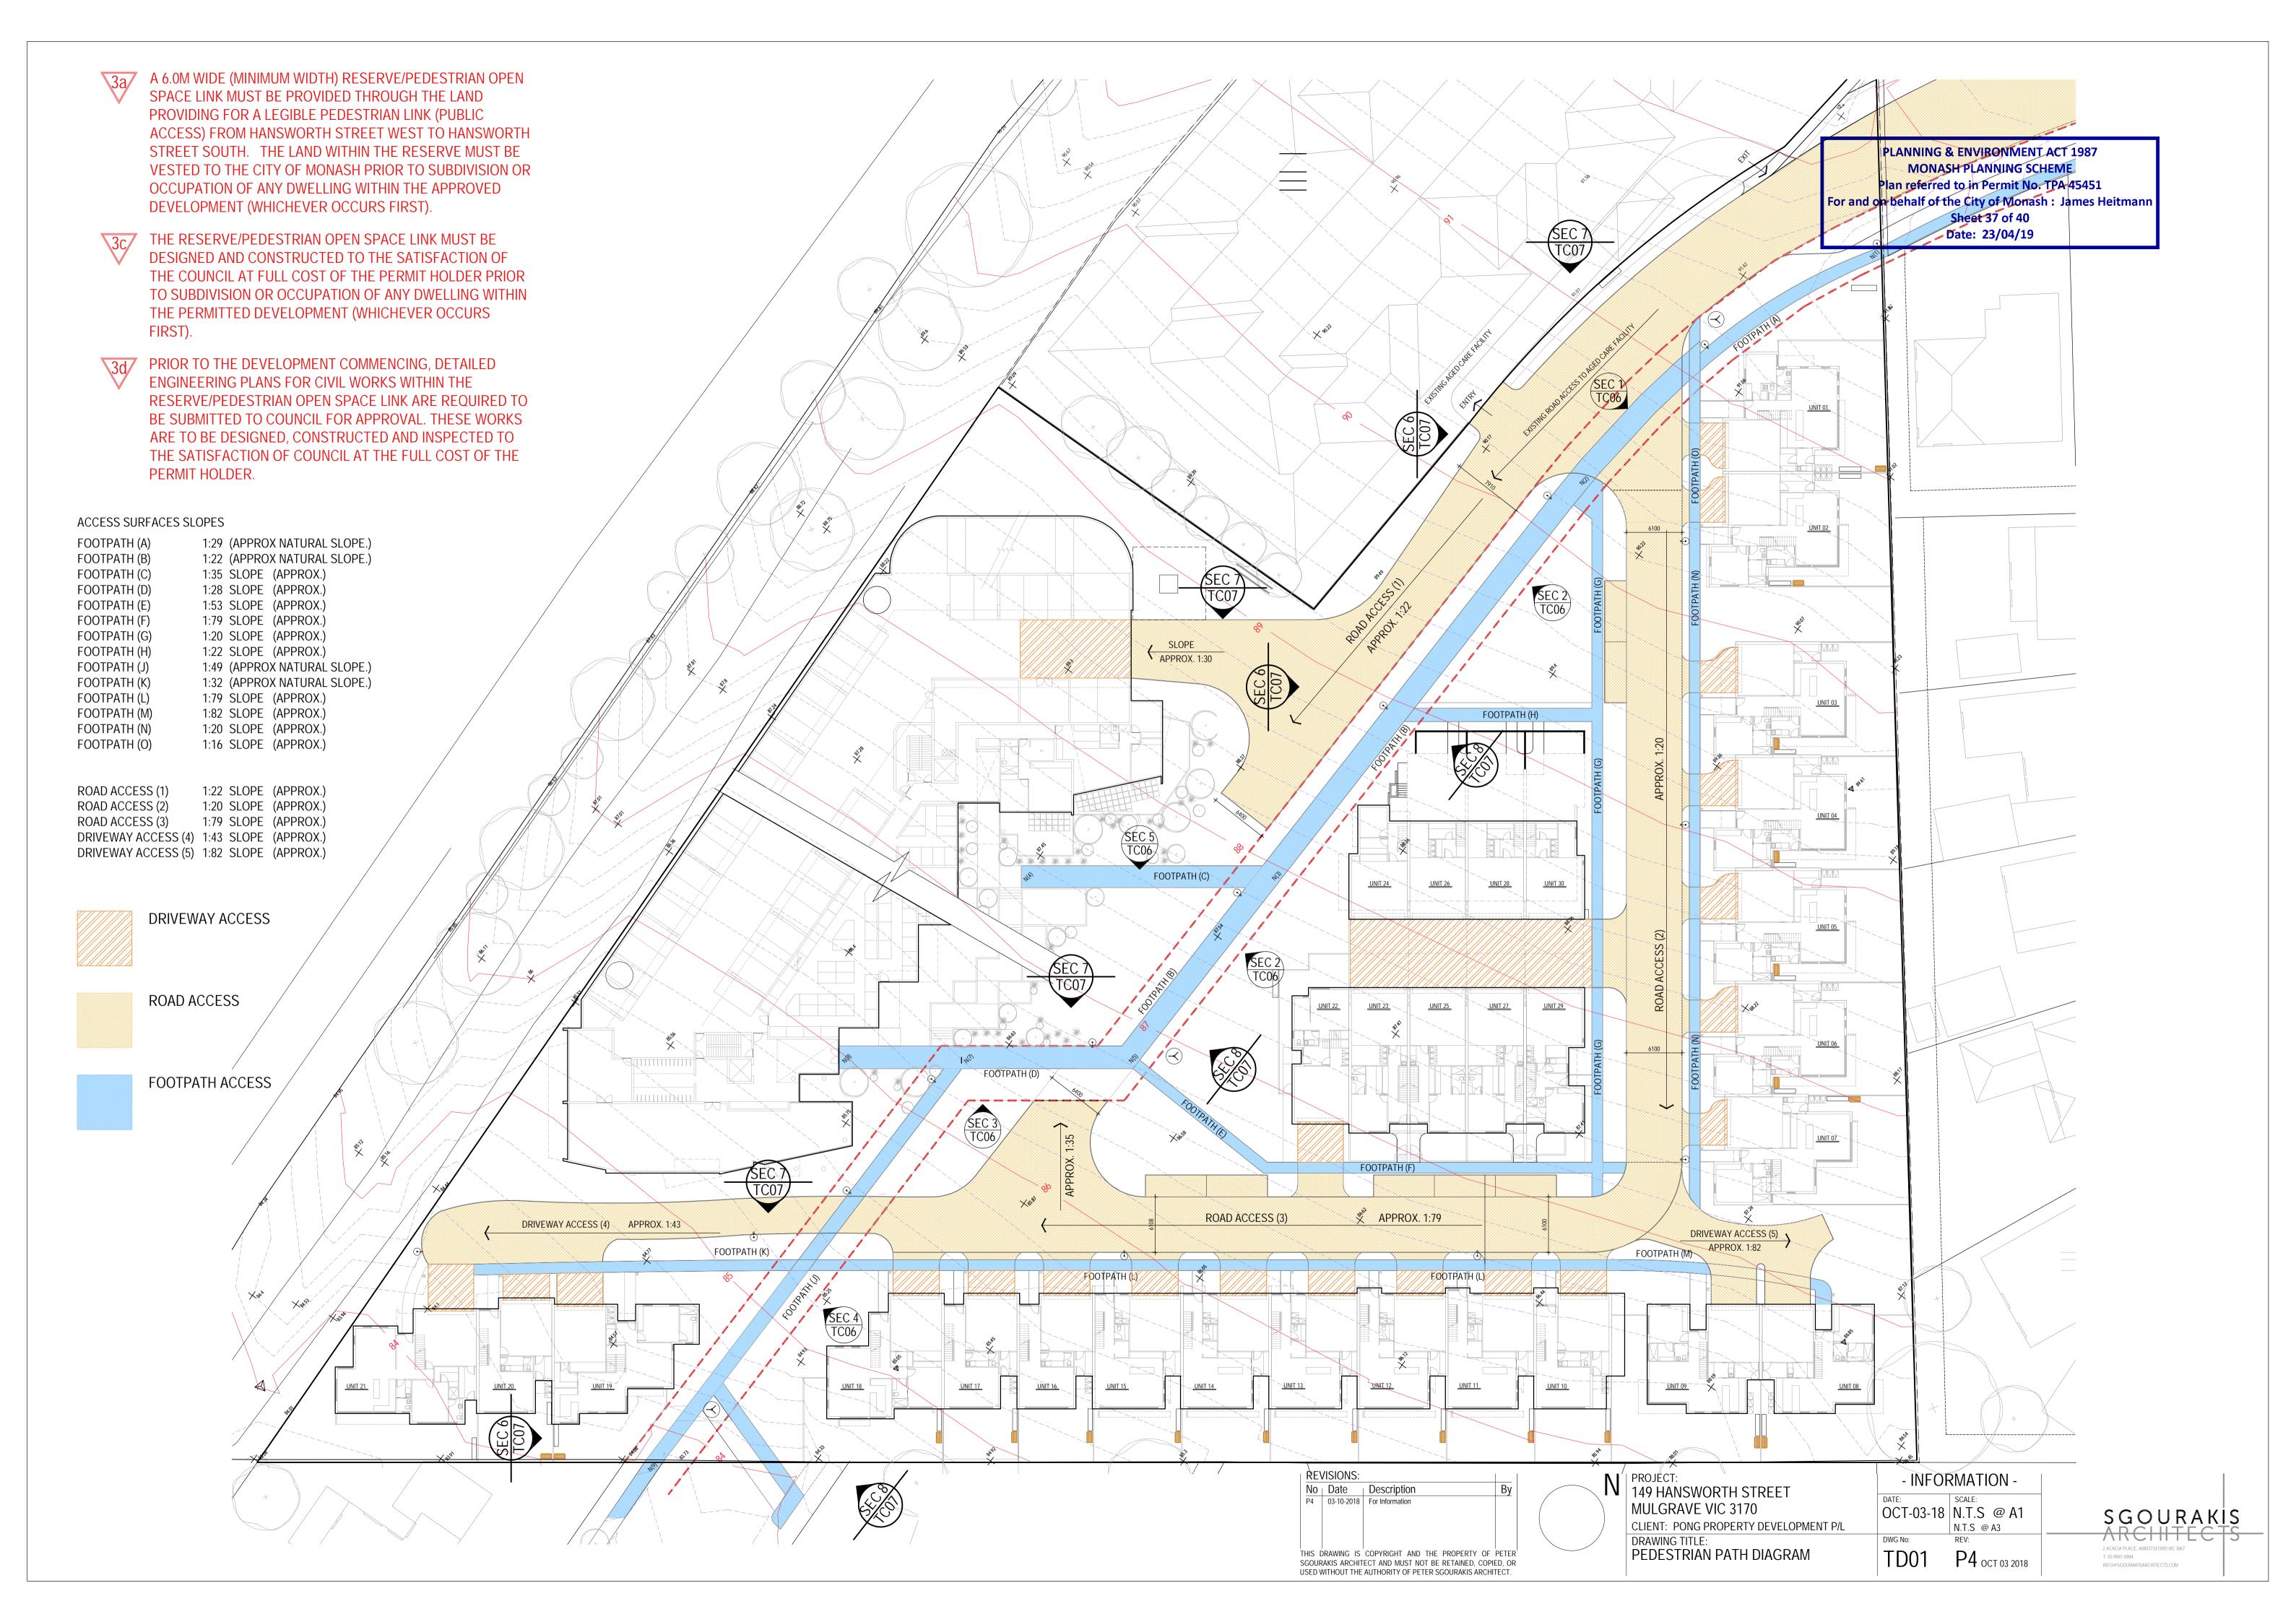

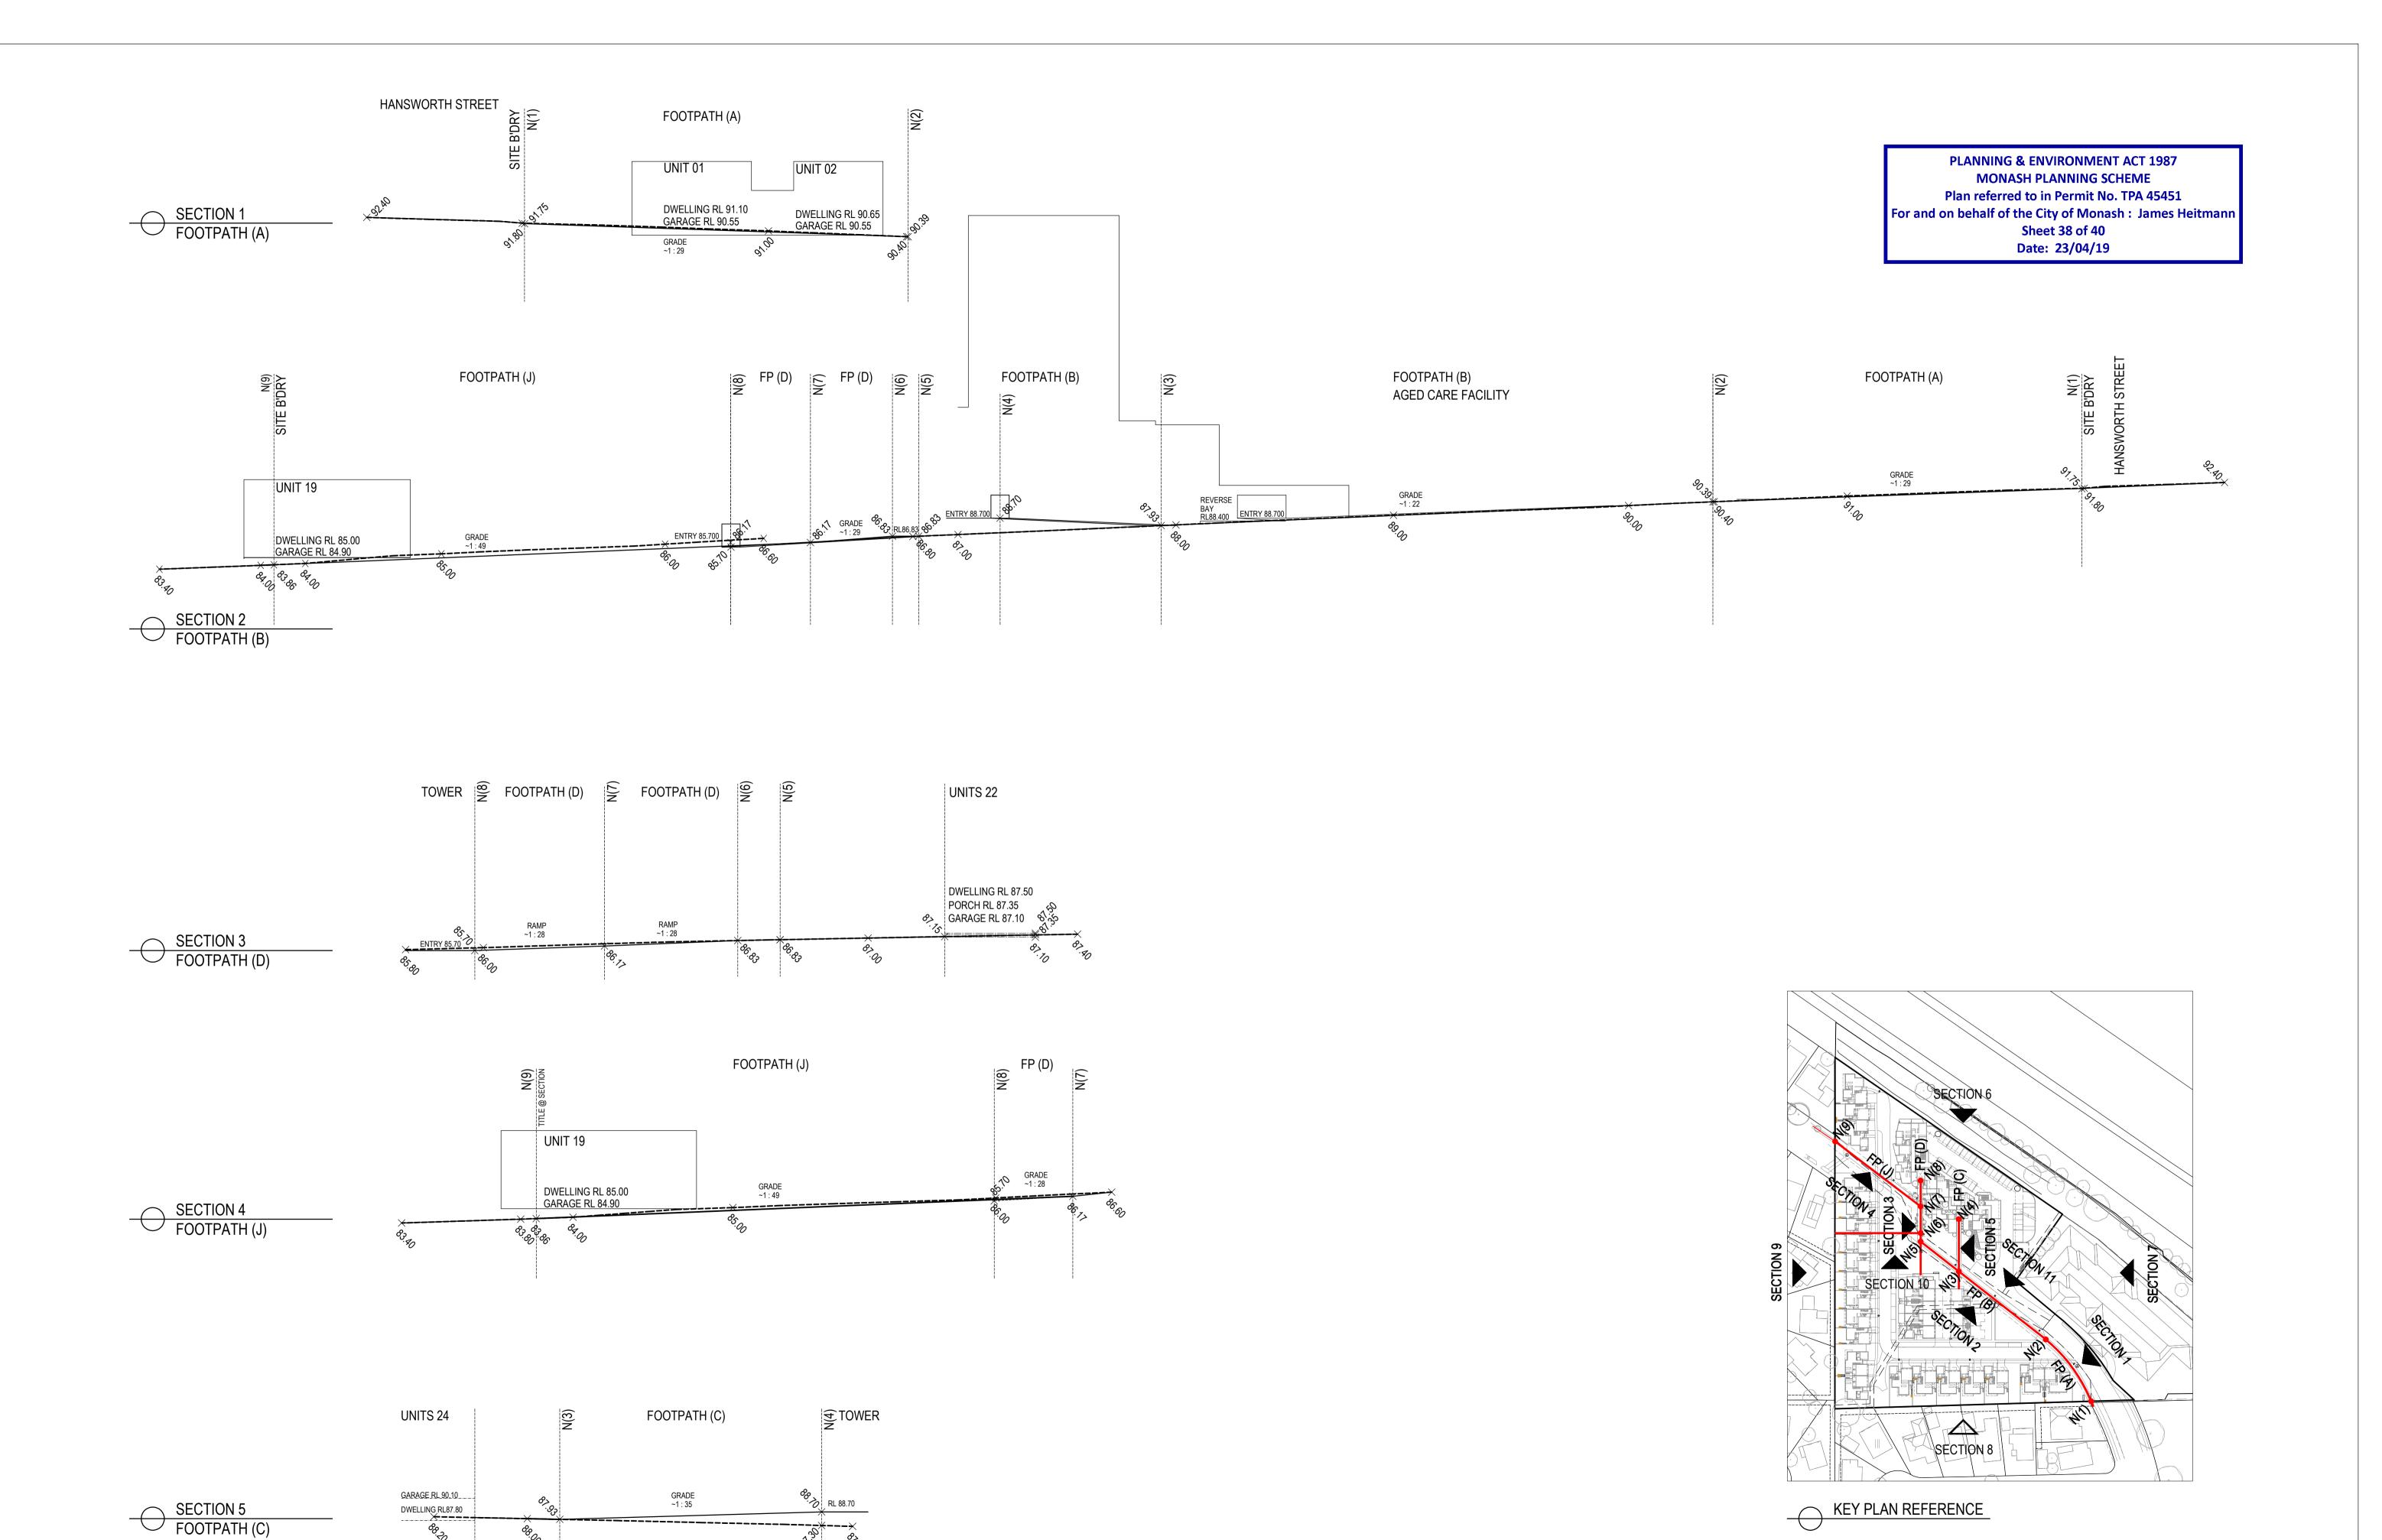

N PROJE 149 H MULO CLIENT DRAWI PATH

PROJECT:
149 HANSWORTH STREET
MULGRAVE VIC 3170
CLIENT: PONG PROPERTY DEVELOPMENT P/L
DRAWING TITLE:
PATHWAY RLs
SECTION 1 - 5

- INFORMATION
DATE: SCALE: 1:300 @ A1 1:600 @ A3

SCALE:
1:300 @ A1
1:600 @ A3

REV:

P5 MAR 18 2019

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